# CALIFORNIA AVE. PEDESTRIAN STREET LOCATION MAP ALMA ST CAL AVE. TRAIN STATION PARK BLVD PARK BLYD PUBLIC PARKING GARAGE BIRCH PUBLIC PARKING GARAGE ASH ST MIMOSA LN PUBLIC PARKING GARAGE EL CAMINO REAL

## 310-320 CALIFORNIA AVENUE CONDITIONAL USE PERMIT PALO ALTO FIT & CAFE

310-320 CALIFORNIA AVE. INTERIOR TENANT **IMPROVEMENT** 

310-320 CALIFORNIA AVE.. PALO ALTO, CA 94306



Ko Architects, Inc. Palo Alto, CA 94301 : 650.853.1845

#### PROJECT DATA PROJECT DESCRIPTION

#### GENERAL INFORMATION

ADDRESS:

124-32-Ø34 310-320 CALIFORNIA AVENUE

PALO ALTO, CA 94306

ZONING DISTRICT: CC(2)(R)(P)

FLOOD ZONE: NONE

HISTORIC CATEGORY: NONE

EXISTING USE: 310 CALIFORNIA AVE.: COMMERCIAL RECREATION

320 CALIFORNIA AVE:

EATING AND DRINKING SERVICES

PROPOSED USE: NO CHANGE

LOT SIZE: 12,000 S.F. (± 0.2755 ACRES)

BUILDING AREA

	EXISTING	PROPOSED
BIØ CALIFORNIA AVE.		
1ST FLOOR	5966 SF	7996 SF
2ND FLOOR	774 SF	2894 SF
TOTAL:	6740 SF	10890 SF

320 CALIFORNIA AVE.		
ENCLOSED OUTDOOR SEATING	400 SF	400 SF
1ST FLOOR	4434 SF	24Ø4 SF
2ND FLOOR	97Ø SF	N/A
TOTAL:	5804 SF	28Ø4 SF

TOTAL BUILDING FLOOR AREA		
1ST FLOOR	10800 SF	10800 SF
2ND FLOOR	1744 SF	2894 SF
TOTAL:	12544 SF	13694 SF
ADDITIONAL BUILDING FLOOR A	AREA:	1150 SF

FAR: 1.14 (2.0:1 MAX ALLOWED)

REQUIRED: SET BACKS:

0-10' TO CREATE AN 8'-12' FRONT SET BACK EFFECTIVE SIDEWALK WIDTH NOT REQUIRED INTERIOR SIDE YARD:

NOT REQUIRED STREET SIDE YARD: NOT REQUIRED REAR SIDE YARD:

FRONT SET BACK: INTERIOR SIDE YARD: STREET SIDE YARD:

±6'-2" ( NO CHANGE) ±2"(NO CHANGE) REAR SIDE YARD: ±4'-2" ( NO CHANGE)

REQUIRED: 37 FT MAX BUILDING HEIGHT: PROVIDED:25 FT (NO CHANGE)

PROVIDED:

±11" ( NO CHANGE)

### PROJECT TEAM

OWNER

MIRCO HORST & NINA NGUYEN Phone: (408) 412-2661 3261 ASH STREET, SUITE A

Contact: MIRCO HORST & NINA NGUYEN PALO ALTO, CA 94306 Email: mircohorstome.com nina@paloaltofit.com

ARCHITECT KO ARCHITECTS, INC. 900 HIGH STREET, STE. 1 PALO ALTO, CA 94301

Phone: (650) 853-1908 Contact: PETER KO, AIA Email: design@koarch.com

### SHEET INDEX

THE PROJECT SCOPE CONSISTS OF A TENANT IMPROVEMENT

FOR 310 CALIFORNIA AVE. FOR PALO ALTO FIT, A ONE-ON-ONE

PERSONAL TRAINING SERVICE BUSINESS WITH NEW RESTROOMS

SHOWERS AND STAFF ROOMS. THE PROJECT PROPOSAL ADDS

PALO ALTO FIT (PAF) IS A PERSONAL TRAINING AND NUTRITION

CONSULTING BOUTIQUE. OUR BUSINESS HOURS ARE FROM 6:00 AM TO 8:00 PM. ALL OUR SERVICES ARE APPOINTMENT-BASED

MOVEMENTS, MOBILITY EXERCISES, AND RESISTANCE TRAINING.

ENSURING A PERSONALIZED EXPERIENCE FOR OUR CLIENTS.

THE PROJECT ALSO INCLUDES A TENANT IMPROVEMENT FOR

NEITHER THERE ARE CHANGES PROPOSED TO THE BUILDING

THE SPACE WILL BE PRIMARILY USED FOR FUNCTIONAL

320 CALIFORNIA AVE., RETAINING ITS CURRENT USE AS A

CAFÉ/WINE BAR WITH NEW PUBLIC RESTROOMS.

FOOTPRINT NOR TO THE BUILDING EXTERIOR.

1,150 SQ. FT. TO THE 2ND FLOOR OF THIS TENANT.

### ARCHITECTURAL:

ASO.O TITLE SHEET AS1.0 SITE PLAN

AS1.1 PHOTOS

AS2.0.1 EXISTING & DEMOLITION FIRST FLOOR PLAN AS2.0.2 EXISTING & DEMOLITION SECOND FLOOR PLAN

AS2.1 PROPOSED IST FLOOR PLAN AS2.2 PROPOSED 2ND FLOOR PLAN

AS2.3 ROOF PLAN

AS5.1 ELEVATIONS

AS6.1 SECTIONS

T-1 SPECIAL TREE PROTECTION INSTRUCTION SHEET

### **VICINITY MAP**



REVISION CUP SUBMITTAL 11.02.2023


C24,487 7-31-25

23-310 PROJECT NO. AUG 2023 DRAWN BY AS NOTED

TITLE SHEET

SHEET

**AS0.0** 

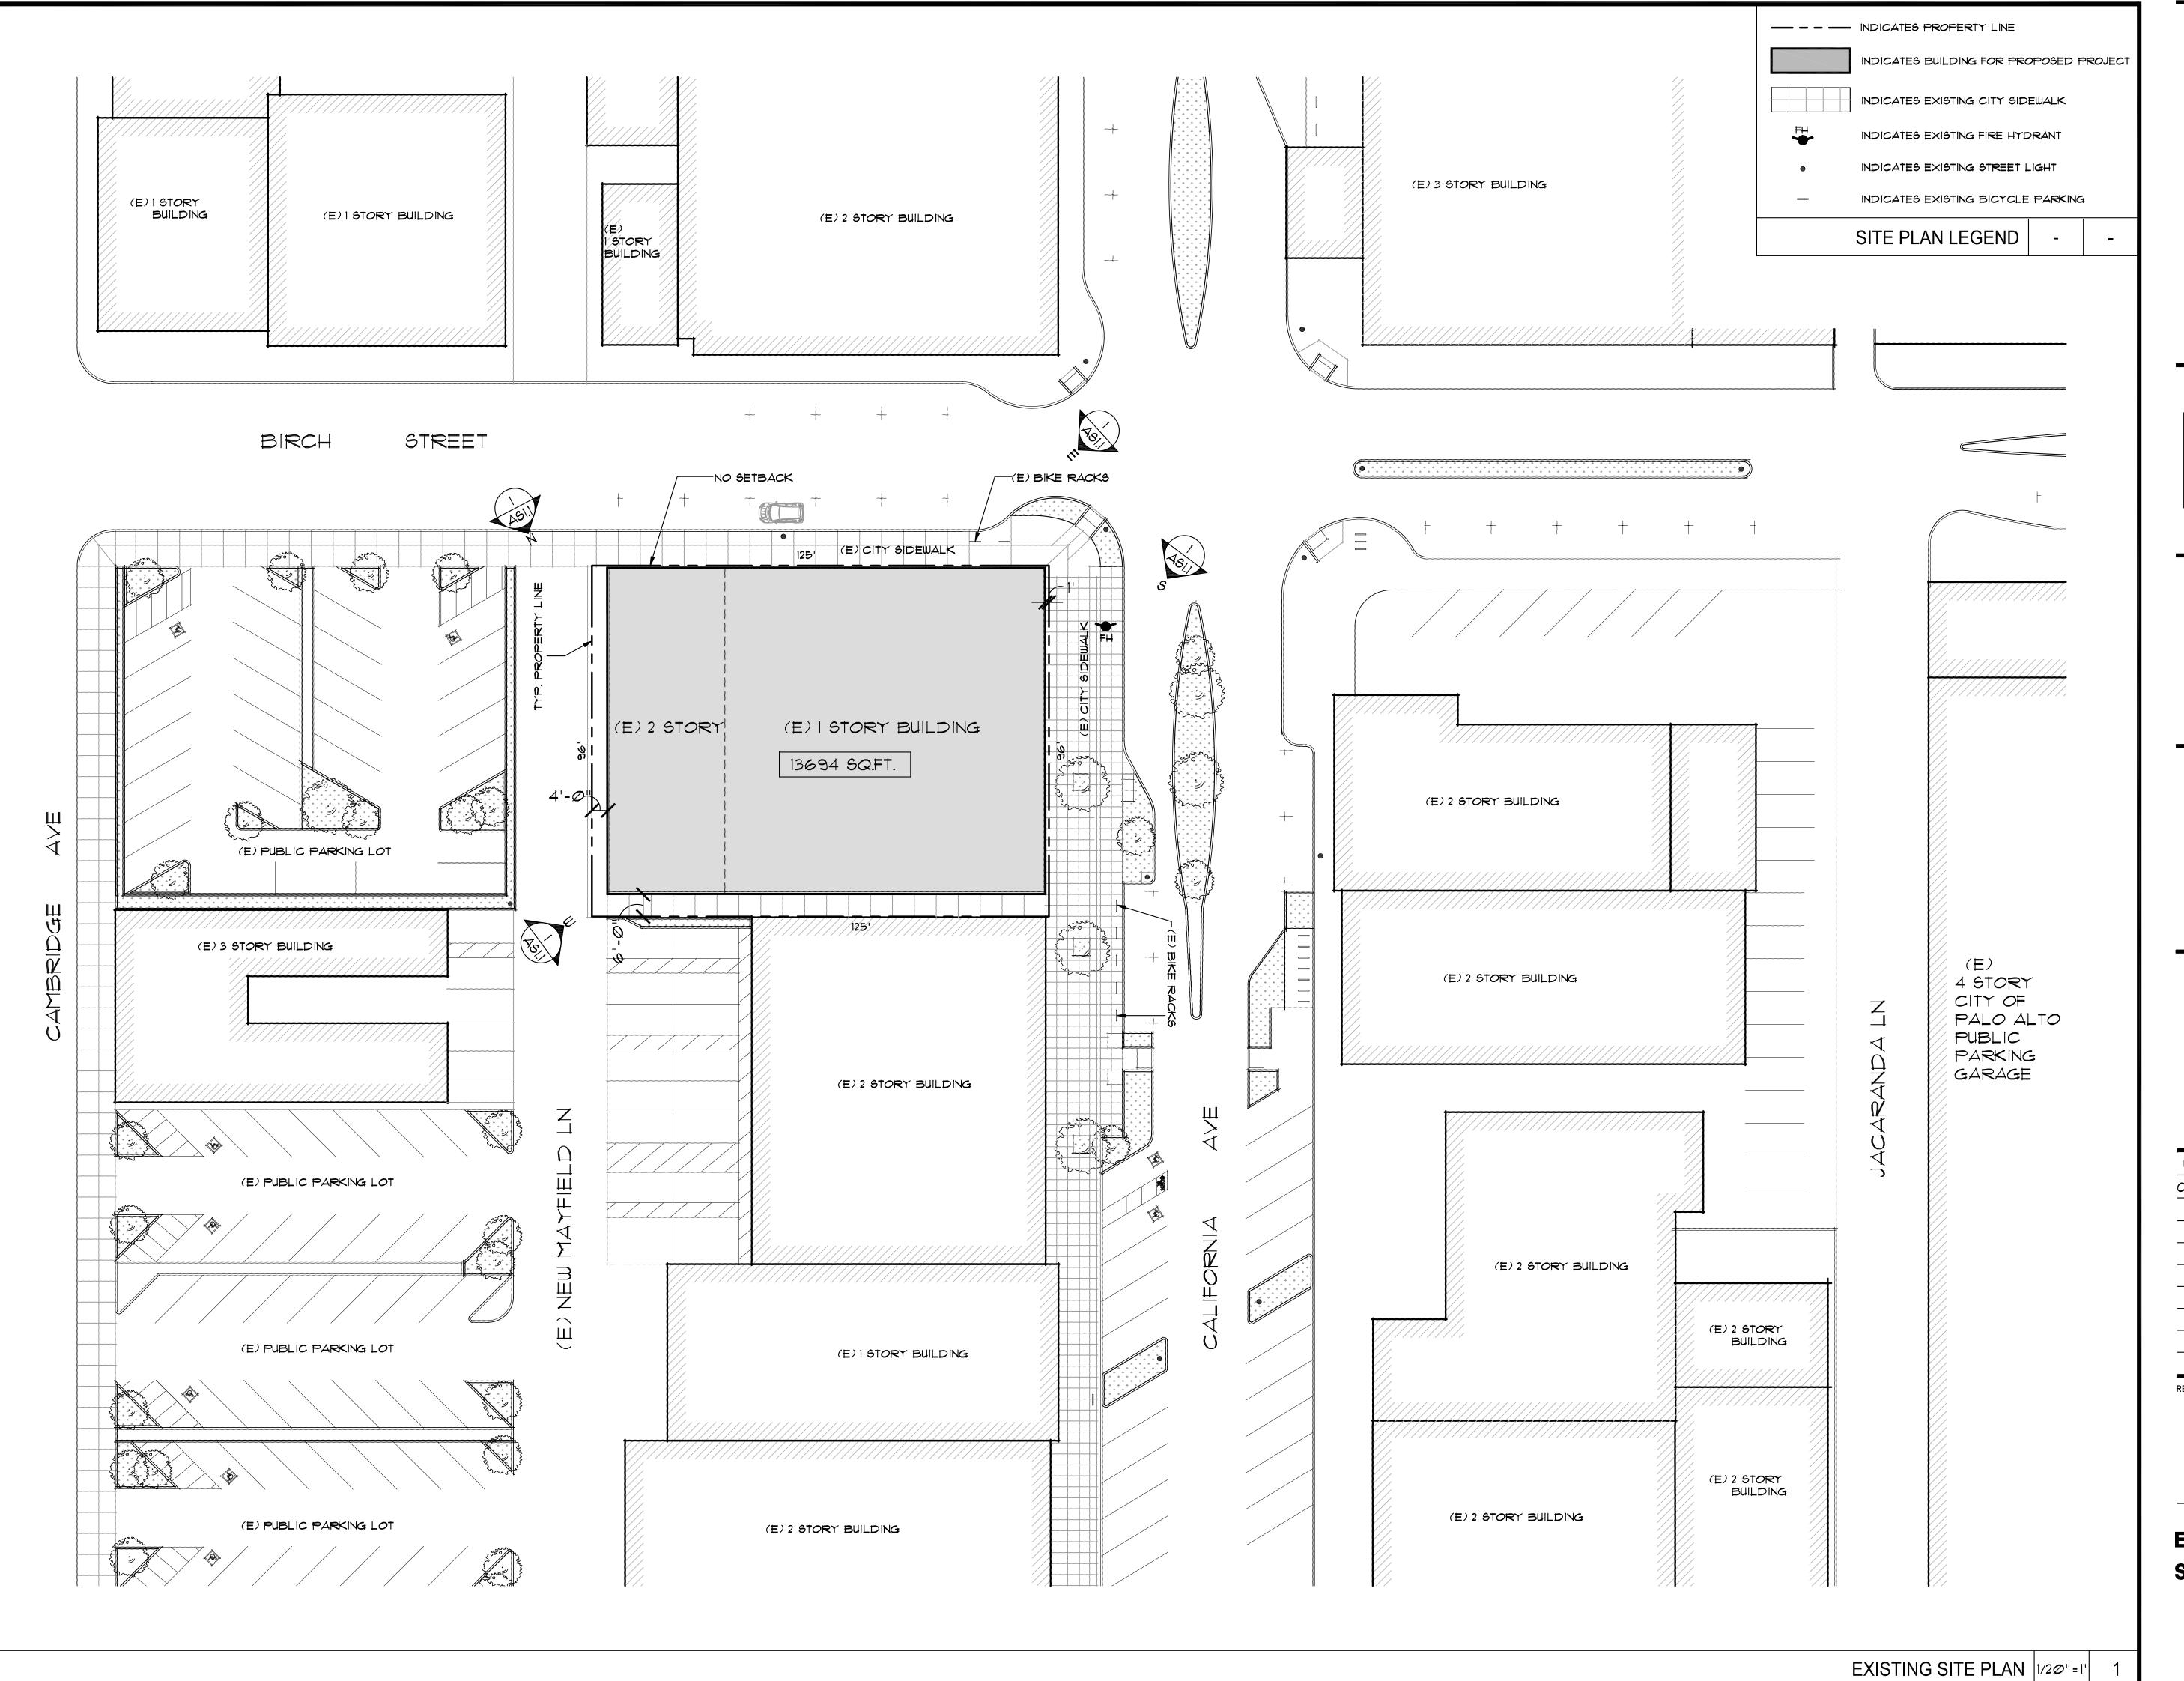

310-320 CALIFORNIA AVE., PALO ALTO, CA 94306



Ko Architects, Inc. 900 High Street, Suite 1 Palo Alto, CA 94301 p: 650.853.1908 f: 650.853.1845



REF. NORTH	
	)

DATE AUG 2023

DRAWN BY SD

SCALE AS NOTED

EXISTING
SITE PLAN

SHEET

**AS1.0** 



SOUTH ELEVATION




EAST ELEVATION



NORTH ELEVATION



WEST ELEVATION- VIEW FROM REAR PARKING LOT

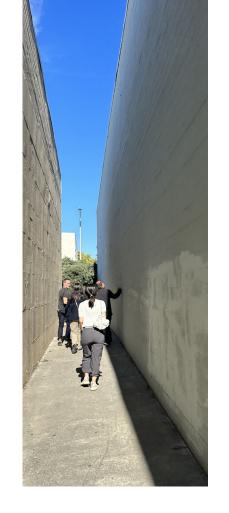



Ko Architects, Inc.

310-320


CALIFORNIA AVE.


**INTERIOR TENANT** 


**IMPROVEMENT** 

WEST ELEVATION- VIEW FROM CALIFORNIA AVE.

EXISTING EXTERIOR ELEVATIONS

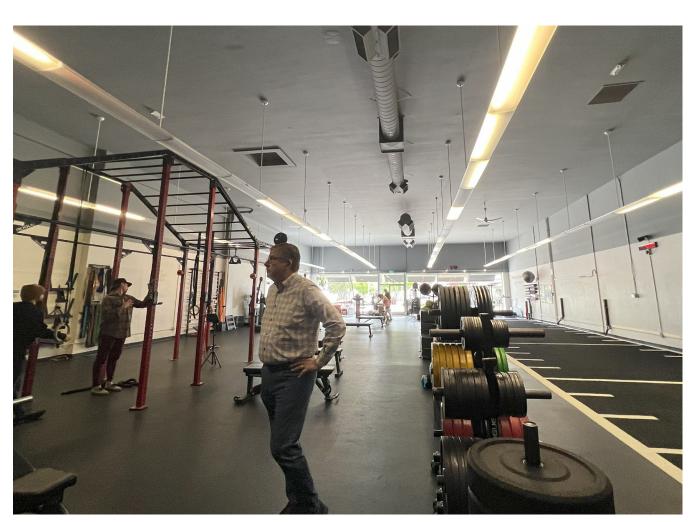

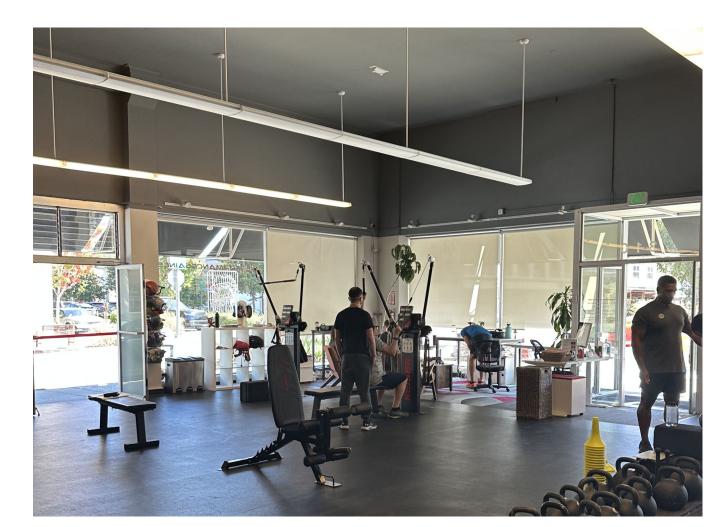

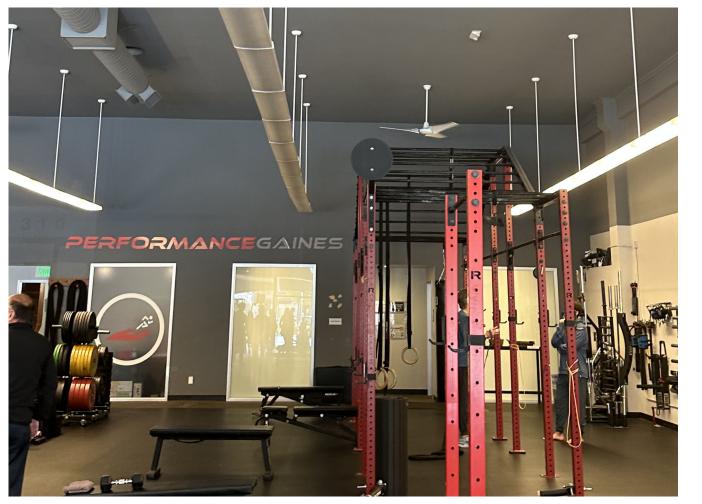



ENTRANCE

TRAINING SPACE

RECEPTION

TRAINING SPACE

EXISTING TENANT 1 - 310 CALIFORNIA AVE.




CAFE



CAFE



ART GALLERY

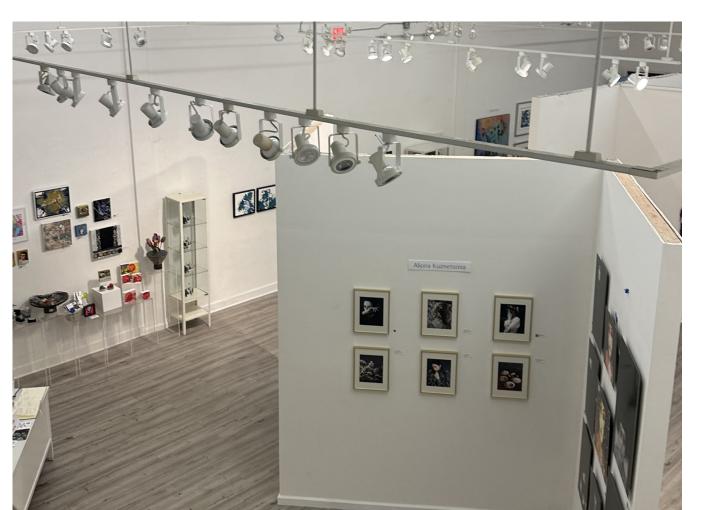

ART GALLERY

**EXISTING BUILDING PHOTOS** 

REVISION

CUP SUBMITTAL

SHEET

PROJECT NO.


11.02.2023

AUG 2023

AS NOTED

EXISTING TENANT 2 - 320 CALIFORNIA AVE.

© KO ARCHITECTS INC.

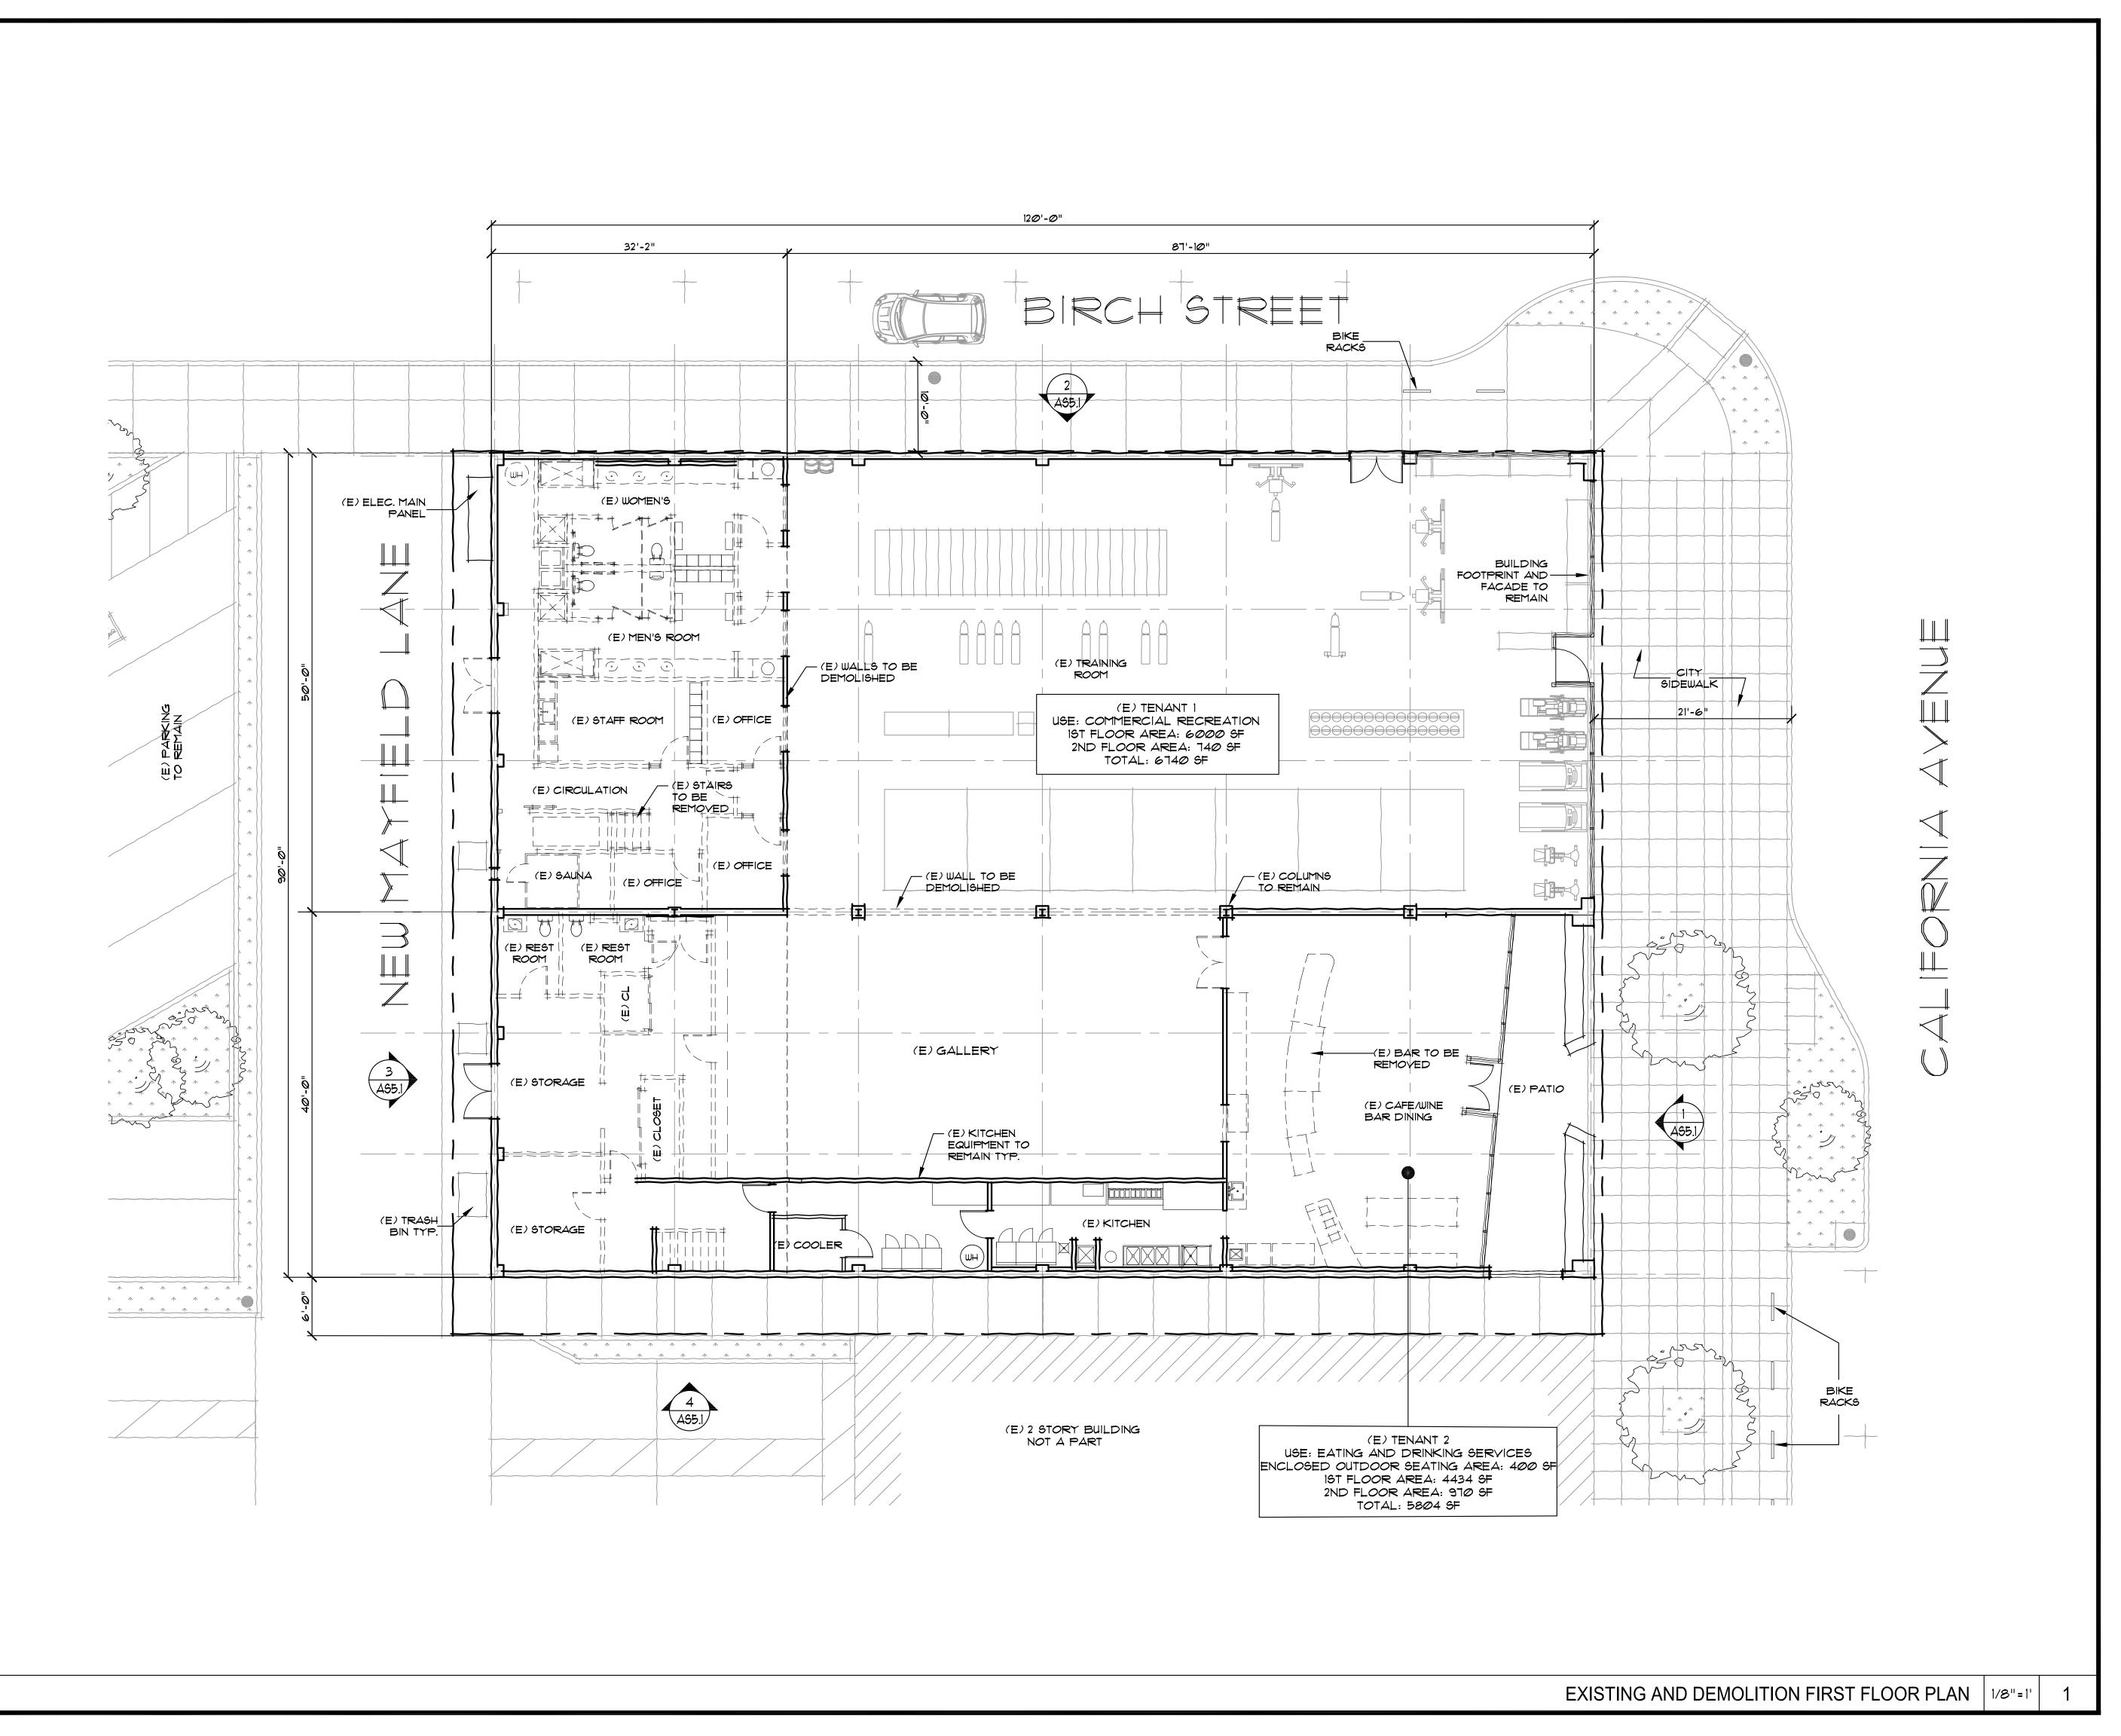

310-320 CALIFORNIA AVE., PALO ALTO, CA 94306



Ko Architects, Inc. 900 High Street, Suite 1 Palo Alto, CA 94301 p: 650.853.1908 f: 650.853.1845




CUP SUBMITTAL	11.02.202

REF. NORTH

PROJECT NO.	23-310
DATE	AUG 2023
DRAWN BY	CZ
SCALE	AS NOTED

**EXISTING AND DEMOLITION** FIRST FLOOR AS2.0.1 **PLAN** 

SHEET

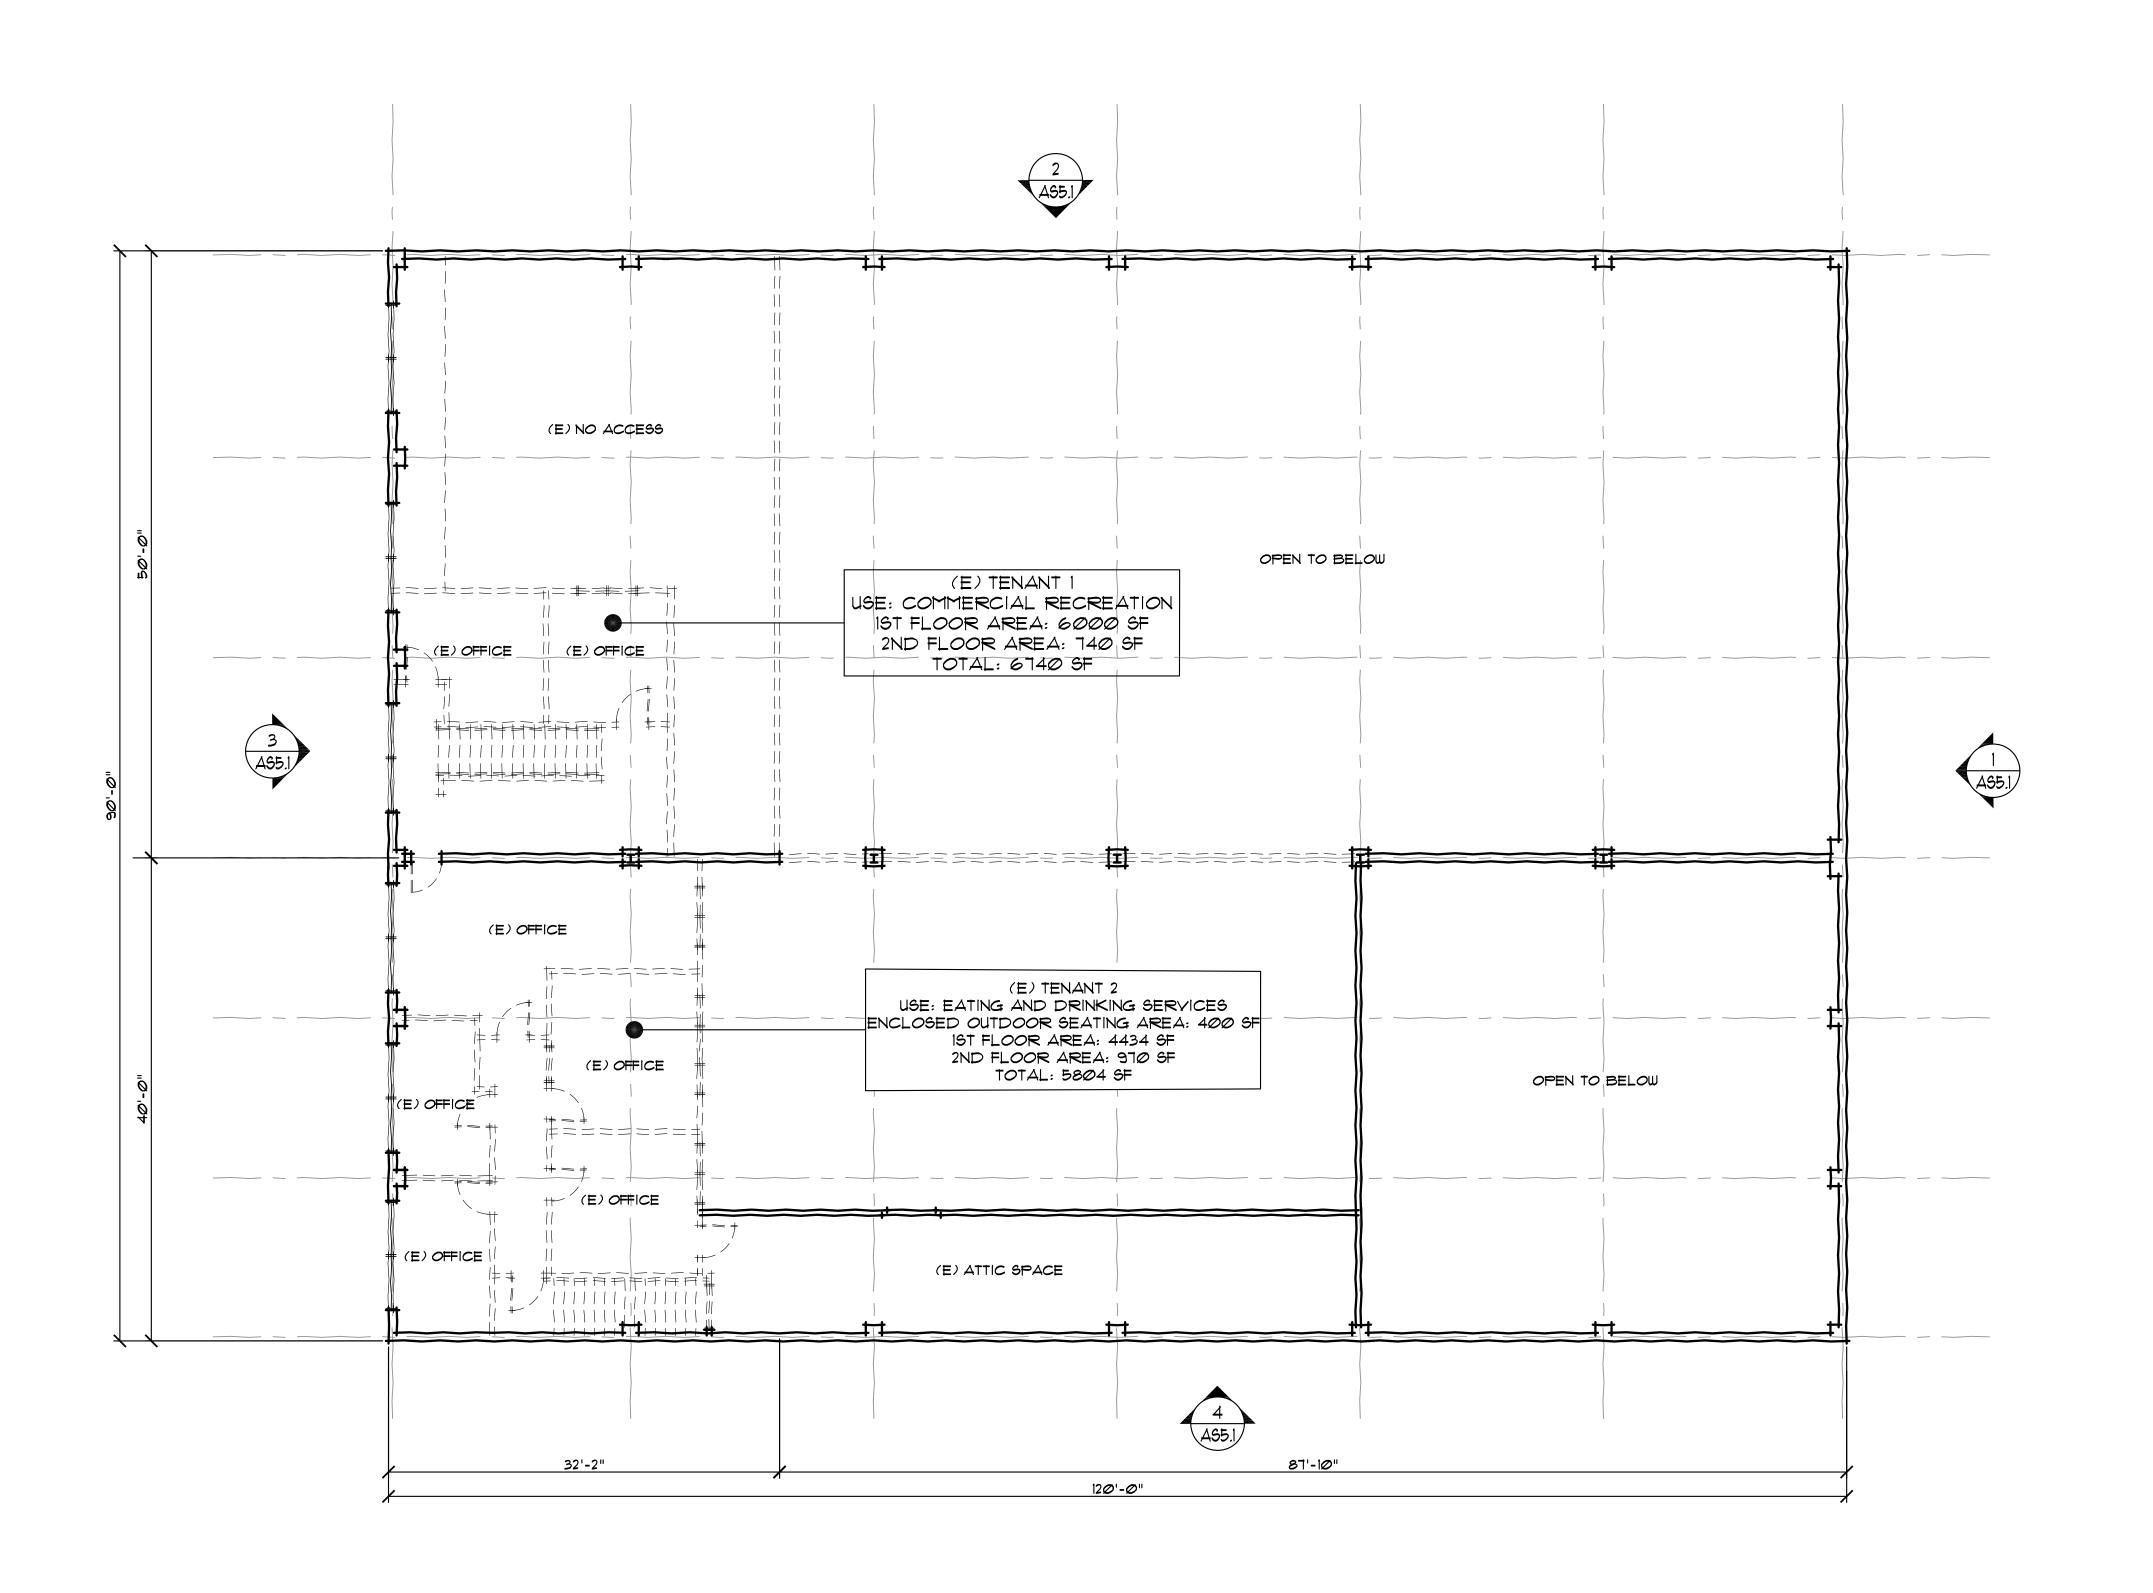

310-320 CALIFORNIA AVE., PALO ALTO, CA 94306



Ko Architects, Inc. 900 High Street, Suite 1 Palo Alto, CA 94301 p: 650.853.1908 f: 650.853.1845



	11.000
CUP SUBMITTAL	11.02.

EF.	NORTH	l	

PROJECT NO. 23-310

DATE AUG 2023


DRAWN BY CZ

SCALE AS NOTED

EXISTING AND
DEMOLITION
SECOND
FLOOR PLAN

SHEET

AS2.0.2

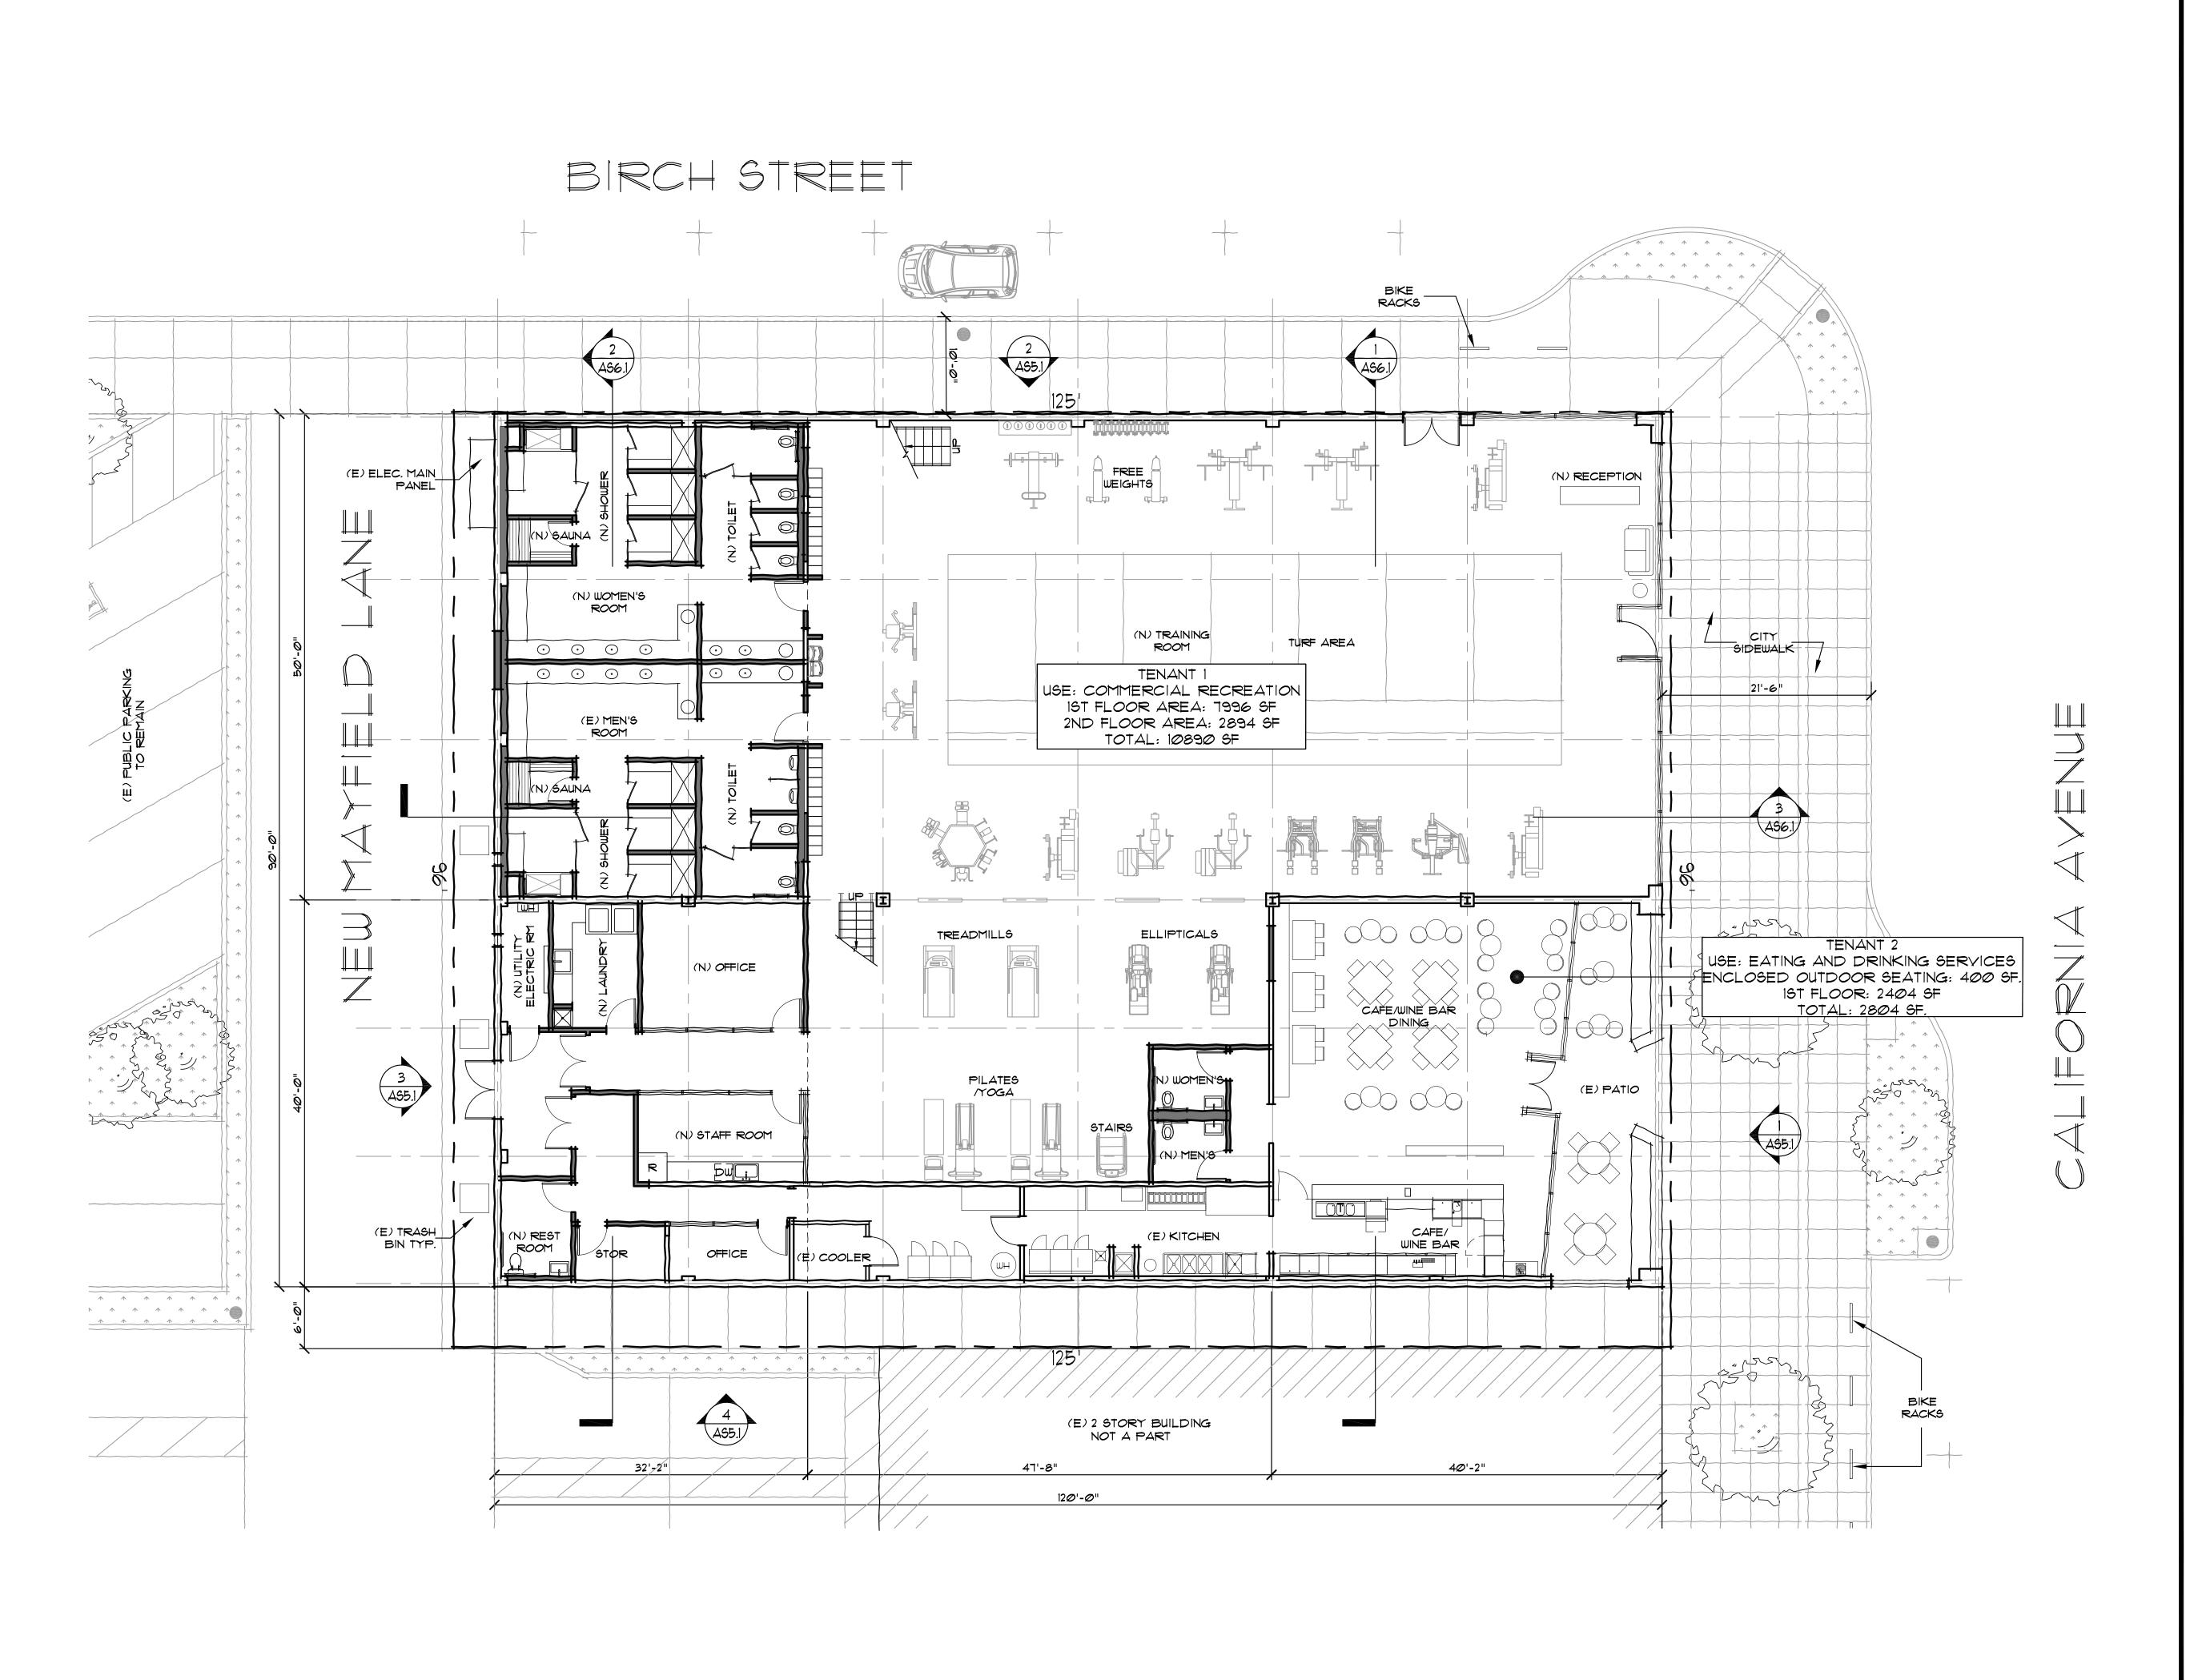

310-320 CALIFORNIA AVE., PALO ALTO, CA 94306



Ko Architects, Inc. 900 High Street, Suite 1 Palo Alto, CA 94301 p: 650.853.1908 f: 650.853.1845



11.02.202:

REF. NORTH

	PROJECT NO.	23-310
	DATE	AUG 2023
ı	DRAWN BY	CZ
	SCALE	AS NOTED

PROPOSED
FIRST
FLOOR PLAN

SHEET

**AS2.1** 

## FREE WEIGHTS TENANT 1 USE: COMMERCIAL RECREATION 1ST FLOOR AREA: 1996 SF 2ND FLOOR AREA: 2894 SF TOTAL: 10890 SF OPEN TO BELOW PILATES /Y*O*GA (N) DRINKING FOUNTAIN (N) PRIVATE TRAINING & STAFF ROOM (N) ALL-GENDER RESTROOM 32'-2"

### 310-320 CALIFORNIA AVE. INTERIOR TENANT **IMPROVEMENT**

310-320 CALIFORNIA AVE., PALO ALTO, CA 94306



Ko Architects, Inc. 900 High Street, Suite 1 Palo Alto, CA 94301 p: 650.853.1908 f: 650.853.1845



CUP SUBMITTAL	11.02.2023

EF. NORTH	PROJECT NO.	
	DATE	,
	DRAWN BY	
	SCALE	Δ

**PROPOSED SECOND** 

SHEET

FLOOR PLAN AS2.2

# (E) ROOF DRAIN AND SCUPPER TO REMAIN $\bigcirc$ (E) ROOF DRAIN AND SCUPPER TO REMAIN (E) EQUIPMENT TO REMAIN (E) EQUIPMENT TO REMAIN (E) EQUIPMENT TO REMAIN (E) ROOF HATCH TO REMAIN $\bigcirc$ (E) ROOF DRAIN AND SCUPPER TO REMAIN (E) 120'-0"

### 310-320 CALIFORNIA AVE. INTERIOR TENANT IMPROVEMENT

310-320 CALIFORNIA AVE., PALO ALTO, CA 94306



Ko Architects, Inc.
900 High Street, Suite 1
Palo Alto, CA 94301
p: 650.853.1908
f: 650.853.1845



CUP SUBMITTAL 11.02.2023

REF. NORTH

PROJECT NO.

DATE

DRAWN BY


SCALE

SHEET

ROOF PLAN **AS2.3** 

AUG 2023

AS NOTED

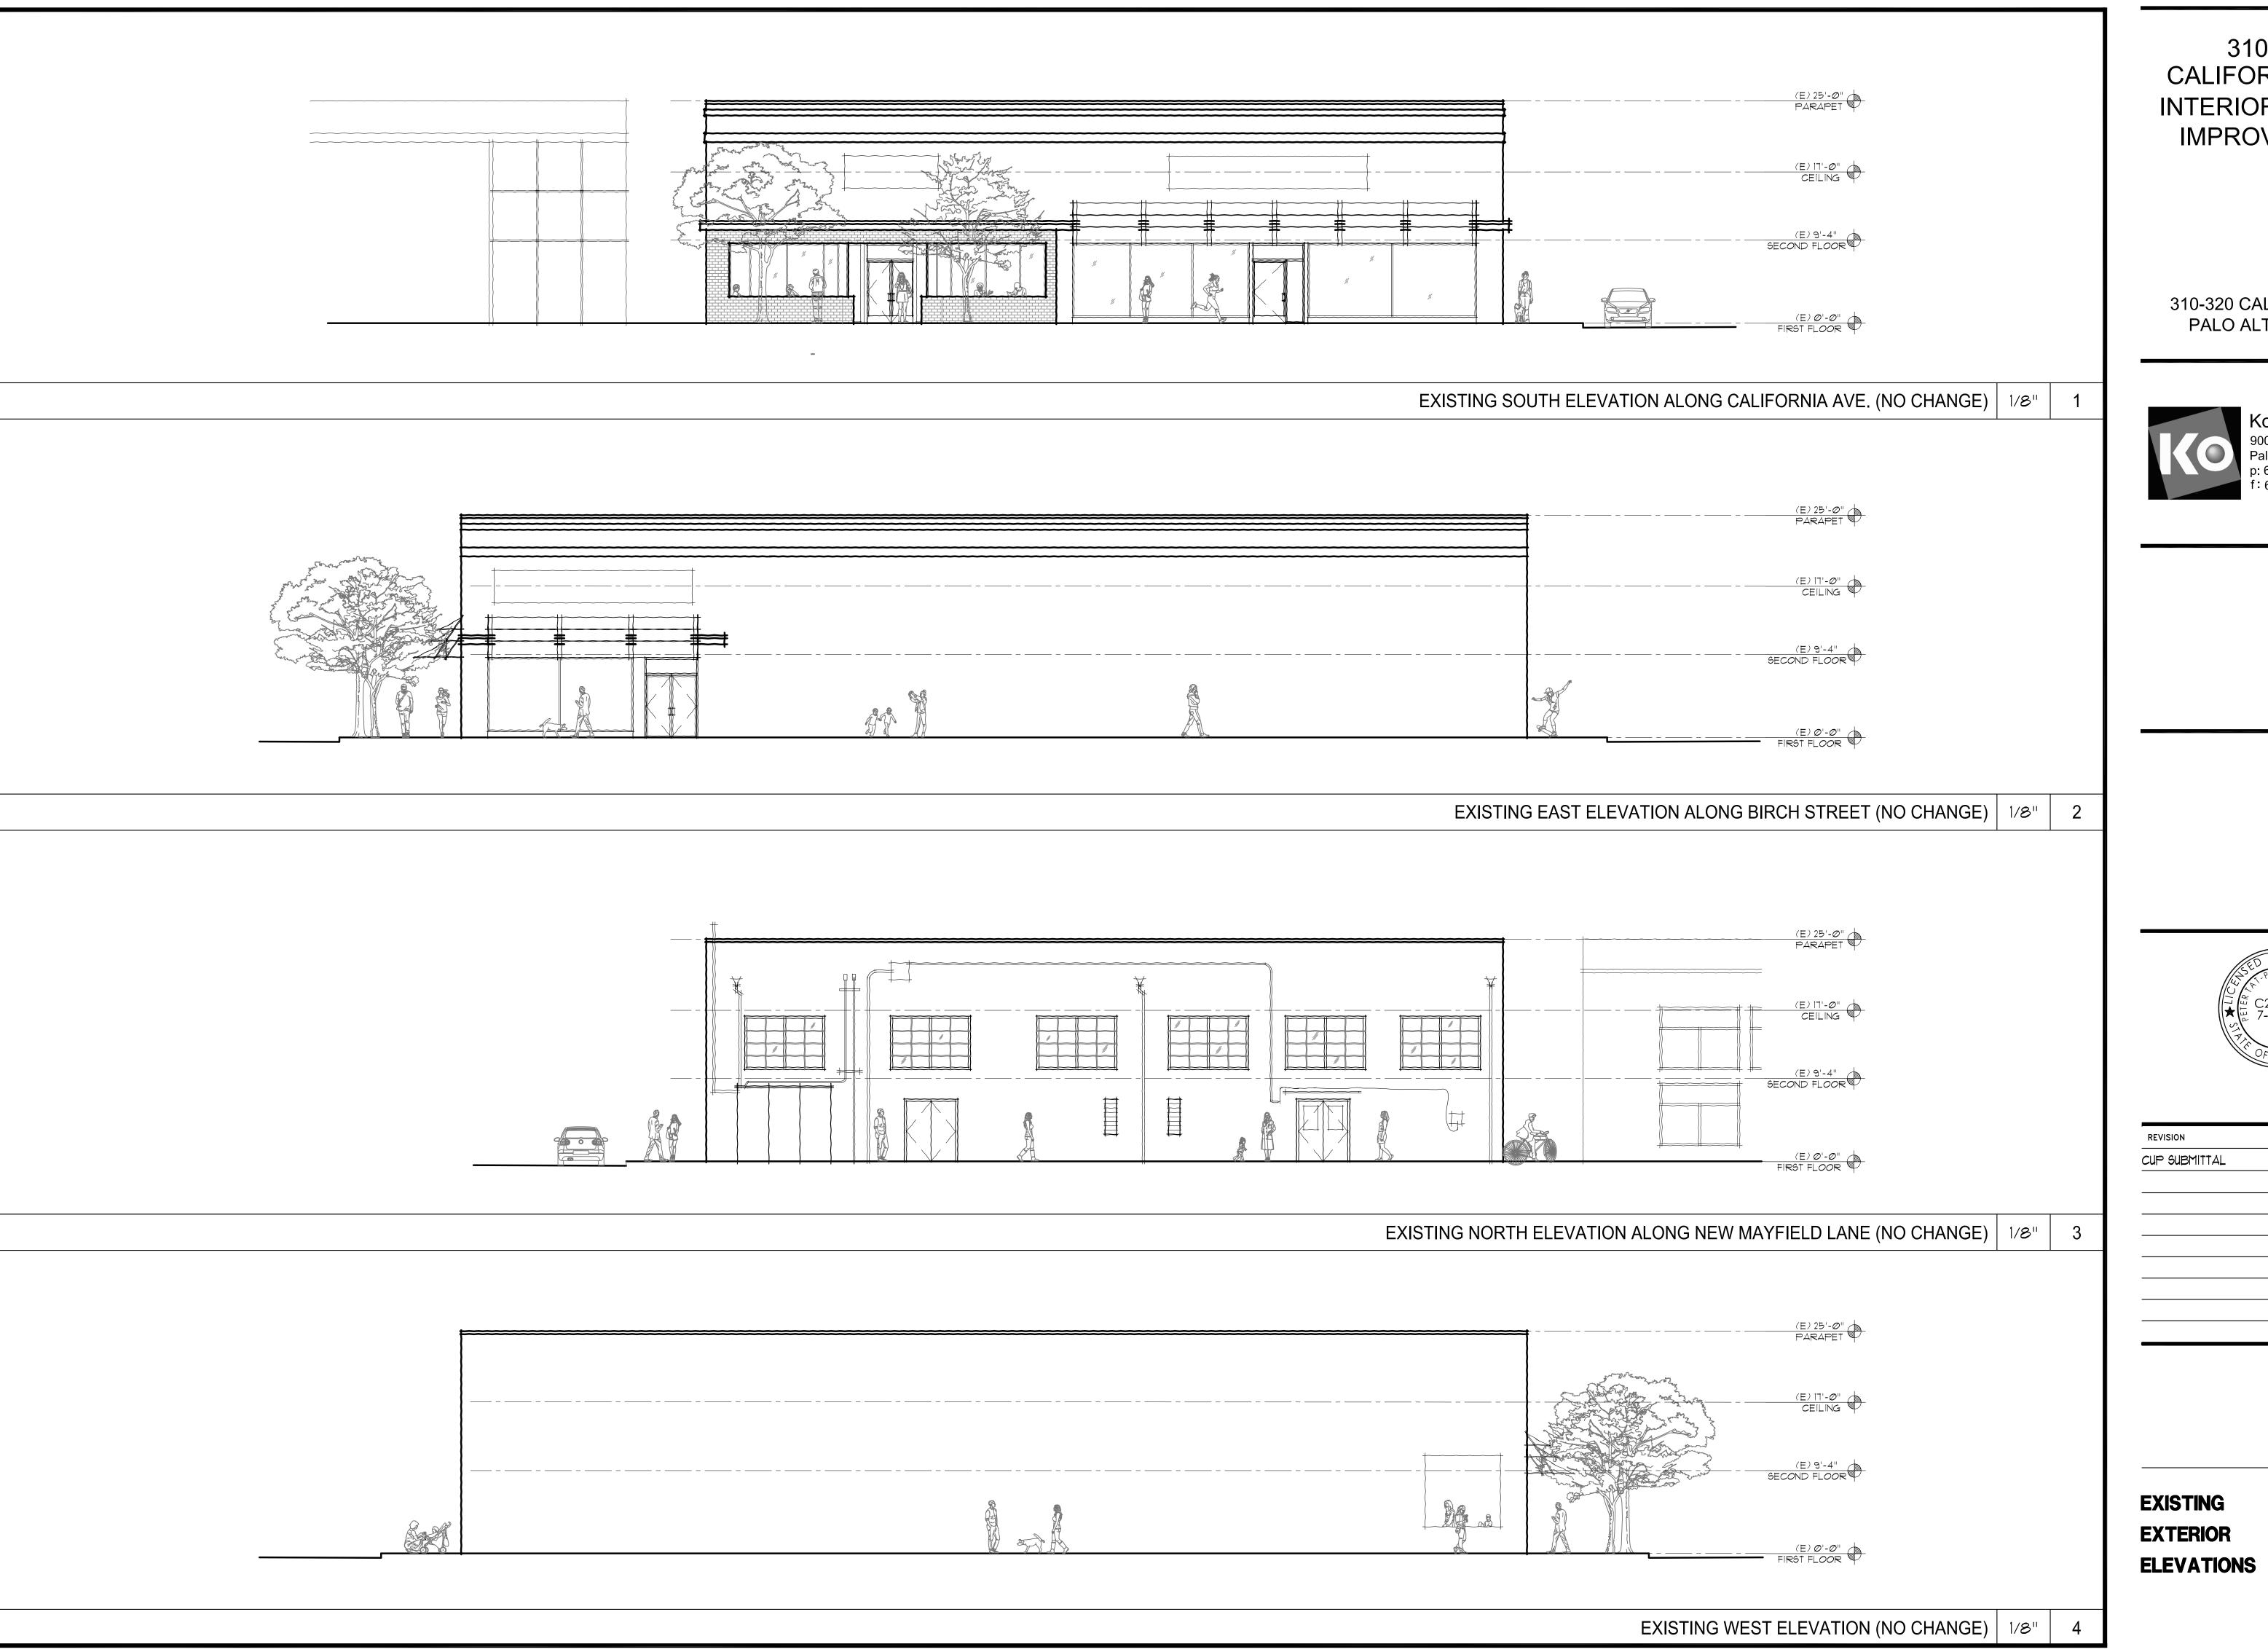

310-320 CALIFORNIA AVE., PALO ALTO, CA 94306






CUP SUBMITTAL 11.02.2023

PROJECT NO.	23-310
DATE	AUG 2023
DRAWN BY	RF
SCALE	AS NOTE

**EXISTING EXTERIOR**  SHEET

**AS5.1** 

© KO ARCHITECTS INC.

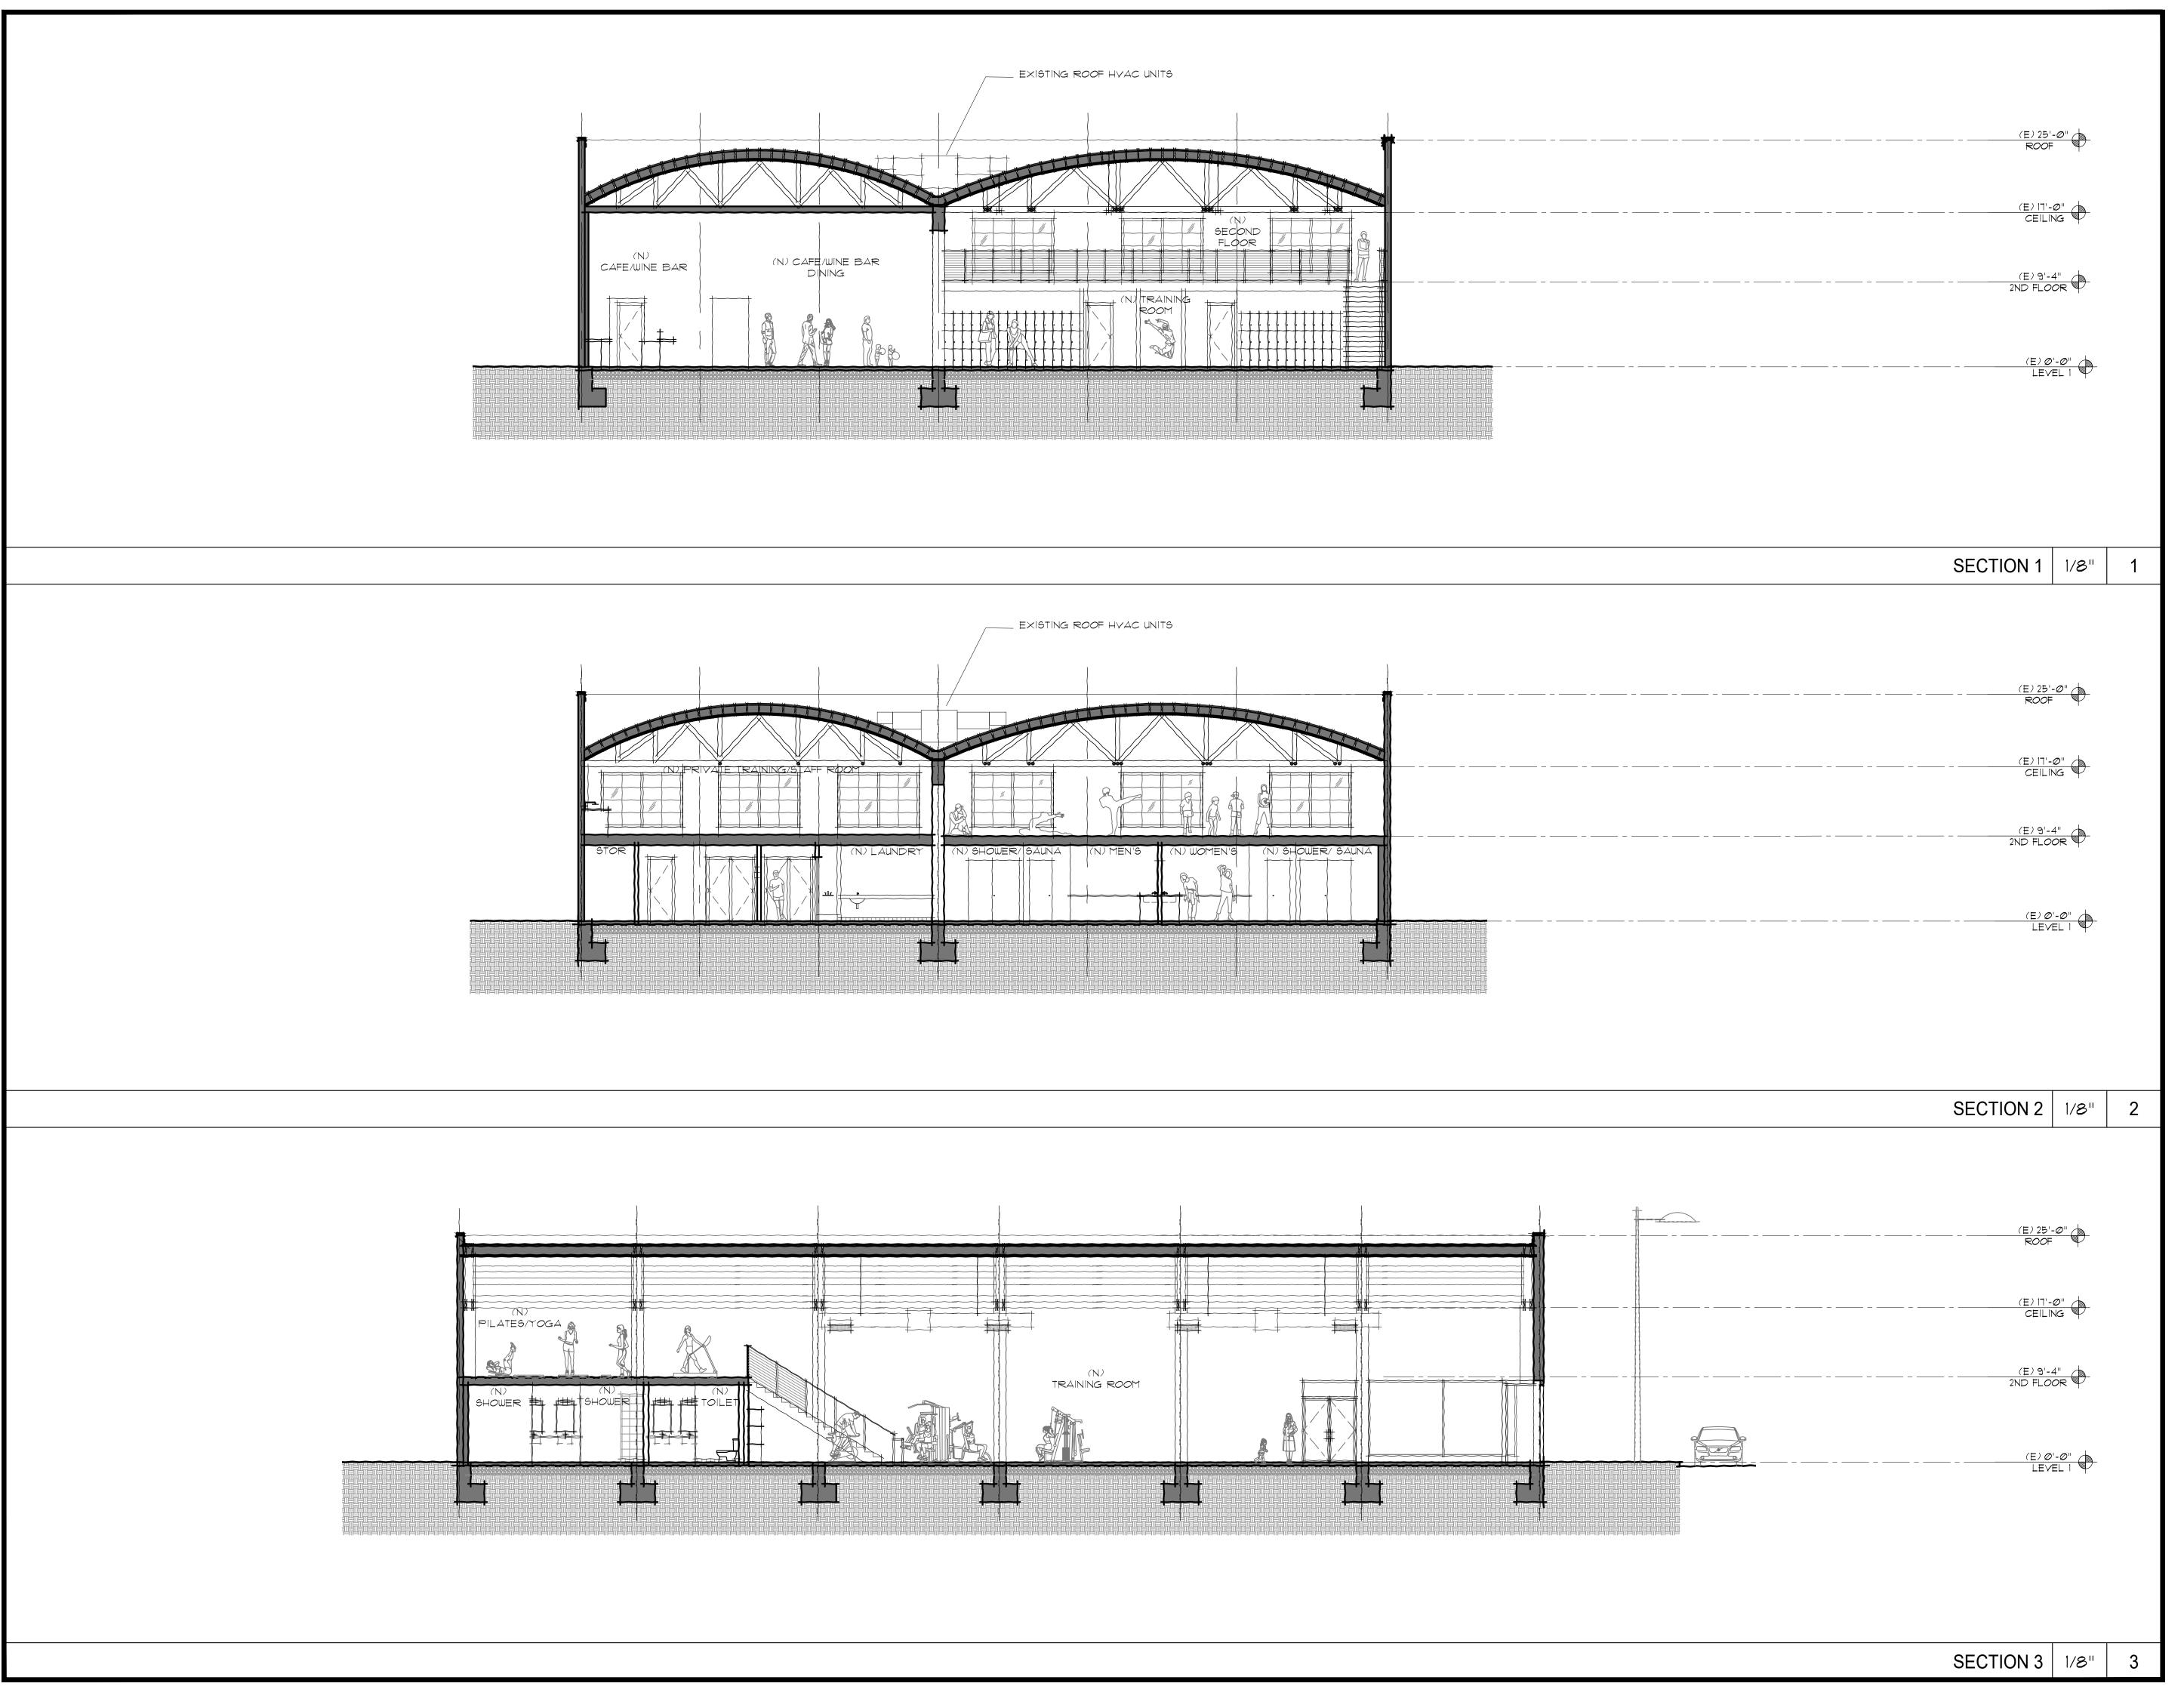

310-320 CALIFORNIA AVE., PALO ALTO, CA 94306



Ko Architects, Inc.
900 High Street, Suite 1
Palo Alto, CA 94301
p: 650.853.1908
f: 650.853.1845



CUP SUBMITTAL 11.02.2023

TROOLOT NO.	22 210
DATE	AUG 2023
DRAWN BY	RR
SCALE	AS NOTED

PROPOSED
BUILDING
SECTIONS

SHEET

**AS6.1** 

© KO ARCHITECTS INC.


## City of Palo Alto


## Tree Protection - It's Part of the Plan!


Make sure your crews and subs do the job right!

Fenced enclosures around trees are essential to protect them by keeping the foliage canopy and branching structure clear from contact by equipment, materials and activities, preserving roots and soil conditions in an intact and non-compacted state, and identifying the Tree Protection Zone (TPZ) in which no soil disturbance is permitted and activities are restricted, unless otherwise approved. An approved tree protection report must be added to this sheet when project activity occurs within the TPZ of a regulated tree.

For detailed information on Palo Alto's regulated trees and protection during development, review the City Tree Technical Manual (TTM) found at www.cityofpaloalto.org/trees/.

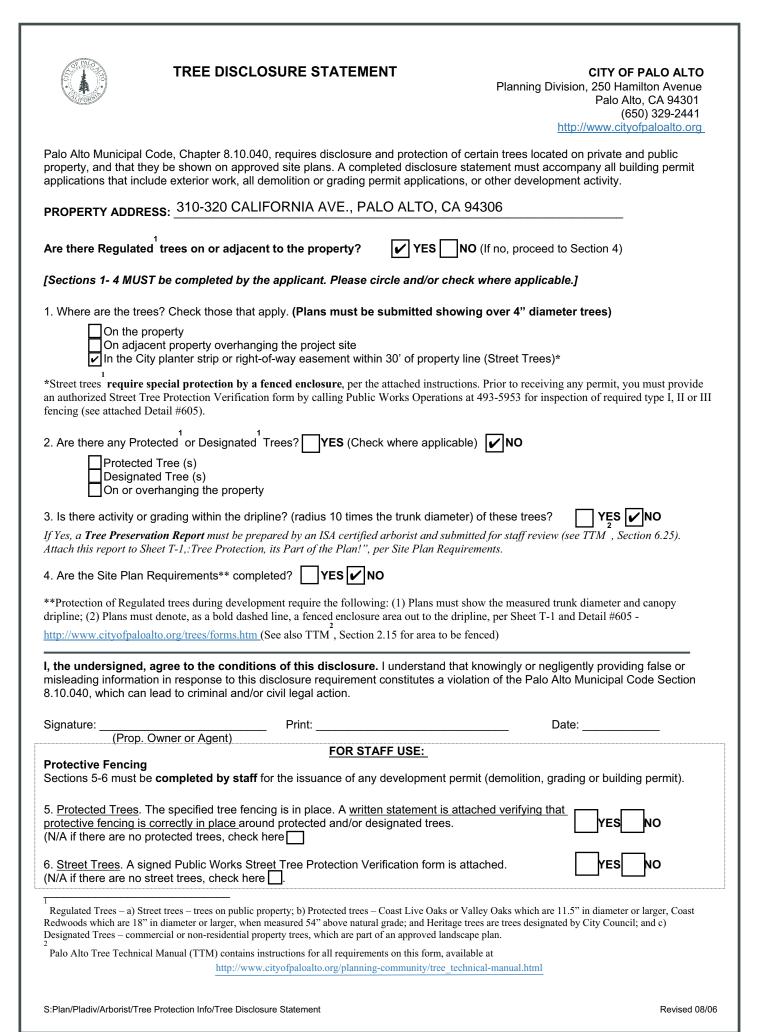

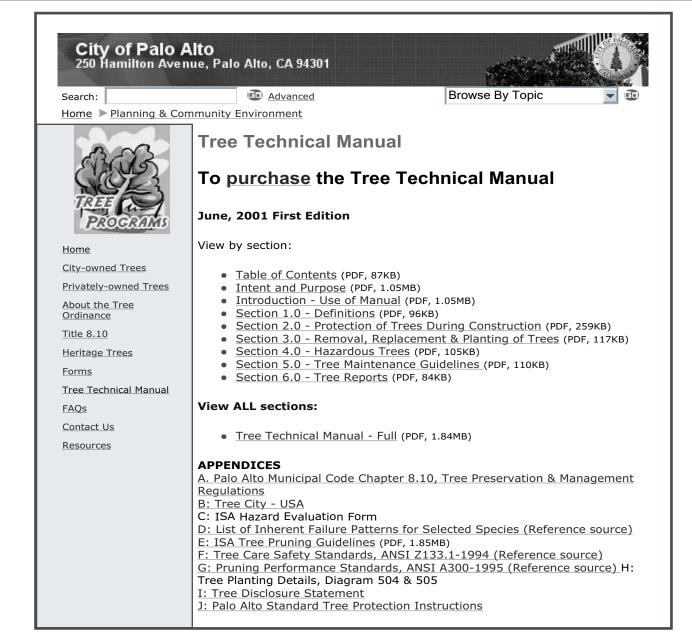

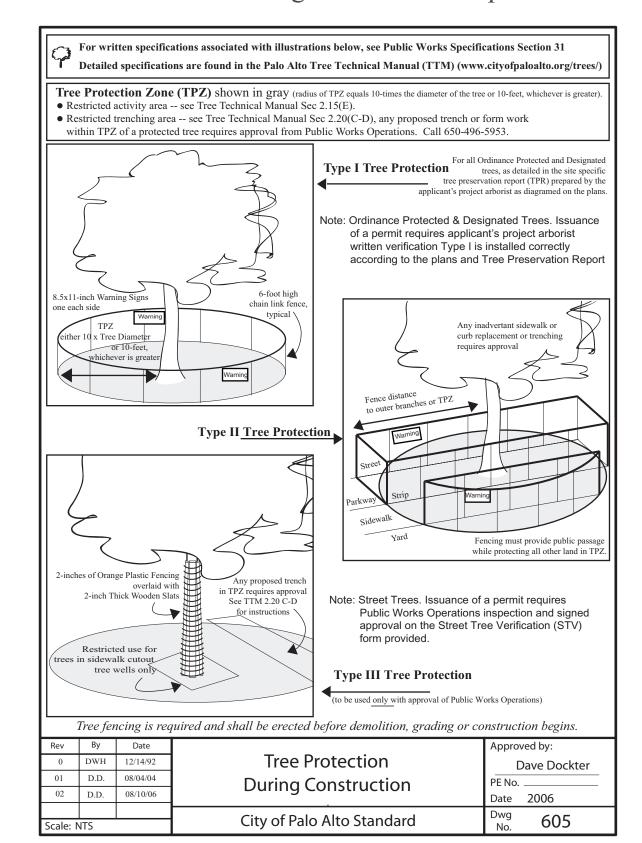

Ê	1	APPENDIX .
*	<b>A</b>	PALO ALTO
	LIFORNIA	STREET TREE PROTECTION INSTRUCTIONSSECTION 31
31-1	Genera	I
	a.	Tree protection has three primary functions, 1) to keep the foliage canopy and branching structure clea from contact by equipment, materials and activities; 2) to preserve roots and soil conditions in an intact and non-compacted state and 3) to identify the Tree Protection Zone (TPZ) in which no soil disturbance is permitted and activities are restricted, unless otherwise approved.
	b.	The Tree Protection Zone (TPZ) is a restricted area around the base of the tree with a radius of ten-time the diameter of the tree's trunk or ten feet; whichever is greater, enclosed by fencing.
31-2	Referen	nce Documents
	a.	<b>Detail 605</b> – Illustration of situations described below.
	b.	Tree Technical Manual (TTM) Forms (http://www.cityofpaloalto.org/trees/)
		<ol> <li>Trenching Restriction Zones (<u>TTM</u>, <u>Section 2.20(C)</u>)</li> <li>Arborist Reporting Protocol (<u>TTM</u>, <u>Section 6.30</u>)</li> </ol>
		3. Site Plan Requirements (TTM, Section 6.35)
		4. Tree Disclosure Statement (TTM, Appendix J)
	c.	Street Tree Verification (STV) Form (http://www.cityofpaloalto.org/trees/forms)
31-3	Executi	on
	a.	<b>Type I Tree Protection:</b> The fence shall enclose the entire TPZ of the tree(s) to be protected throughout the
		life of the construction project. In some parking areas, if fencing is located on paving or concrete that will no be demolished, then the posts may be supported by an appropriate grade level concrete base, if approved by
		Public Works Operations.
	b.	<b>Type II Tree Protection:</b> For trees situated within a planting strip, only the planting strip and yard side of
		the TPZ shall be enclosed with the required chain link protective fencing in order to keep the sidewalk and
	_	street open for public use.
	c.	<b>Type III Tree Protection:</b> To be used <u>only</u> with approval of Public Works Operations. Trees situated in a tree well or sidewalk planter pit, shall be wrapped with 2-inches of orange plastic fencing from the ground to
		the first branch and overlaid with 2-inch thick wooden slats bound securely (slats shall not be allowed to dig
		into the bark). During installation of the plastic fencing, caution shall be used to avoid damaging any
		branches. Major limbs may also require plastic fencing as directed by the City Arborist.
	d.	<b>Size, type and area to be fenced.</b> All trees to be preserved shall be protected with six (6') foot high chain link fences. Fences are to be mounted on two-inch diameter galvanized iron posts, driven into the ground to a depth of at least 2-feet at no more than 10-foot spacing. Fencing shall extend to the outer branching, unless specifically approved on the STV Form.
	e.	"Warning' signs. A warning sign shall be weather proof and prominently displayed on each fence at 20-foo
		intervals. The sign shall be minimum 8.5-inches x 11-inches and clearly state in half inch tall letters: "WARNING - Tree Protection Zone - This fence shall not be removed and is subject to a fine according to PAMC Section 8.10.110."
	f.	<b>Duration</b> . Tree fencing shall be erected before demolition; grading or construction begins and remain in
		place until final inspection of the project, except for work specifically allowed in the TPZ. Work or soil
		disturbance in the TPZ requires approval by the project arborist or City Arborist (in the case of work around Street Trees). Excavations within the public right of way require a Street Work Permit from Public Works.
	g.	During construction
		1. All neighbors' trees that overhang the project site shall be protected from impact of any kind.
		<ol> <li>An heighbors trees that overhain the project site shall be projected from impact of any kind.</li> <li>The applicant shall be responsible for the repair or replacement plus penalty of any publicly owned trees that are damaged during the course of construction, pursuant to Section 8.04.070 of the Palo Alto Municipal Code.</li> </ol>
		<ul> <li>3. The following tree preservation measures apply to all trees to be retained:</li> <li>a. No storage of material, topsoil, vehicles or equipment shall be permitted within the TPZ.</li> <li>b. The ground under and around the tree canopy area shall not be altered.</li> </ul>
		<ul><li>c. Trees to be retained shall be irrigated, aerated and maintained as necessary to ensure survival.</li></ul>

Table 2	2-2 Palo Alto Tree Technical Manual
	CONTRACTOR & ARBORIST INSPECTION SCHEDULE
	Reference: the Palo Alto Tree Technical Manual is available at www.cityofpaloalto.org/environment/
ALL CE	HECKED ITEMS APPLY TO THIS PROJECT:
1.	Inspection of Protective Tree Fencing. For Public Trees, the Street Tree Verification Form shall signed by the City Arborist. For Protected Trees, the project site arborist shall provide an initial Monthly Tree Activity Report form with a photograph verifying that he has conducted a field inspection of the trees and that the correct type of protective fencing is in place around the designated tree protection zone (TPZ) prior to issuance of a demolition, grading, or building perm (See TTM, Verification of Tree Protection, Section 1.39).
	Pre-Construction Meeting. Prior to commencement of construction, the applicant or contractor st conduct a pre-construction meeting to discuss tree protection with the job site superintendent, grading operators, project site arborist, City Arborist, and, if a city maintained irrigation system is involved, the Parks Manager (Contact 650-496-6962).
	Inspection of Rough Grading or Trenching. Contractor shall ensure the project site arborist performs an inspection during the course of rough grading or trenching adjacent to or within the TPZ to ensure trees will not be injured by compaction, cut or fill, drainage and trenching, and if required, inspect aeration systems, tree wells, drains and special paving. The contractor shall prov the project arborist at least 24 hours advance notice of such activity.
	Monthly Tree Activity Report Inspections. The project site arborist shall perform a minimum monthly activity inspection to monitor and advise on conditions, tree health and retention or, immediately if there are any revisions to the approved plans or protection measures. The Tree Technical Manual Monthly Tree Activity Report format shall be used and sent to the Planning De landscape review staff no later than 14 days after issuance of building permit date. Fax to (650) 32 2154. (See TTM, Monthly Tree Activity Inspection Report, Addendum 11 & section 1.17).
	Special activity within the Tree Protection Zone. Work in the TPZ area (see also #7 below) requires the direct onsite supervision of the project arborist (see TTM, Trenching, Excavation & Equipment, Section 2.20 C).
	Landscape Architect Inspection. For discretionary development projects, prior to temporary or final occupancy the applicant or contractor shall arrange for the Landscape Architect to perform a on site inspection of all plant stock, quality of the materials and planting (see TTM, Planting Quality, Section 5.20.1 A) and that the irrigation is functioning consistent with the approved construction plans. The Planning Dept. landscape review staff shall be in receipt of written verification of Landscape Architect approval prior to scheduling the final inspection, unless otherwise approved.
7.	List Other (please describe as called out in the site Tree Preservation Report, Sheet T-1, T-2, etc.
	*

City of Palo A Tree Department Public Works Operations PO Box 10250 Palo Alto, Co. 650/496-5953 FAX: 650/85 treeprotection@CityofPaloA	A 94303 52-9289	Verification of Street Tree Protection	
		n. Mail or FAX this form along with signed Tree s Tree Staff will inspect and notify applicant.	
APPLICATION DATE:	10/20/2023		
ADDRESS/LOCATION OF STREET TREES TO BE PROTECTED:	310-320 C	ALIFORNIA AVE., PALO ALTO, CA 94	
APPLICANT'S NAME:	Palo Alto F	IT	
APPLICANT'S ADDRESS:	425 Portag	e Ave, Palo Alto, CA 94306	
APPLICANT'S TELEPHONE & FAX NUMBERS:	650-441-0347		
This section to be filled out by City Tree St	aff		
The Street Trees at the above address(es) are adequately		YES □ NO* □	
protected. The type of protection used is:		* If NO, go to #2 below	
Inspected by:			
Date of Inspection:			
address are <u>NOT</u> adequately protected. The following modifications are required:  Indicate how the required modifications were communicated to the applicant.			
	1		
Subsequent Inspection  Street trees at above address were found to be adequately protected:	* If I	YES NO* NO* NO, indicate in "Notes" below the disposition of case.	
Subsequent Inspection Street trees at above address were found	* If I		
Subsequent Inspection  Street trees at above address were found to be adequately protected:	* If I		
Subsequent Inspection  Street trees at above address were found to be adequately protected:  Inpsected by:	* If I		

				RCA/IS	A Certified Arborist #W Contact
	M	onthly Tree A	ctivity Repo	rt- Constructio	
	spection ate:	Site address:	Contractor- Main Site Contact	#1: Job site superinte Company: Email:	
	spection	Palo Alto, CA	Information	Job site Office: Cell: Mail:	
			Also present:	:	
D	istribution:	City of Palo Alto     Others	Attn: Dave Dockter	Dave.dockter@cityofp 650-329-2440	aloalto.org
<ol> <li>3.</li> <li>4.</li> <li>5.</li> </ol>	a. Pre-co b. Inspec c. Detern Field Obser a. Tree P b. Trench Action Item a. Tree P b. Root z c. Schede Photographs	nstruction meeting requite to verify that tree profinine if field adjustment vations (general site-wirotection Fences (TPF) sing has/will occur is (list site-wide, by tree rotection Fence (TPF); one buffer material (would sewer trench, found	the sub-content with sub-content with sub-content with sub-content on the state of the state of the sub-content with sub-cont	n place visions may be needed  ual tree number)  be satisfied) and Date Du # x, x, x)  alled next	
-	•				
7.	Past visits (1	ist carry-over items sat	isfied/still outstandin	g)	
	espectfully st	ıbmitted,			
P	roject site arb	orist itact information (Inclu	de email, cell#, and n	nailing)	

## ---WARNING--Tree Protection Zone

This fencing shall not be removed without City Arborist approval (650-496-5953)

Removal without permission is subject to a \$500 fine per day\*


\*Palo Alto Municipal Code Section 8.10.110

City of Palo Alto Tree Protection Instructions are located at <a href="http://www.city.palo-alto.ca.us/trees/technical-manual.html">http://www.city.palo-alto.ca.us/trees/technical-manual.html</a>

SPECIAL INSPECTIONS	PLANNING DEPARTMENT
TREE PROTECTION IN	SPECTIONS MANDATORY
PAMC 8.10 PROTECTED TREES. CONTRACTOR SHAL REQUIRED TREE INSPECTION AND SITE MONITORIN REPORTS TO THE PLANNING DEPARTMENT LANDSC BUILDING PERMIT ISSUANCE.	
BUILDING PERMIT DATE:	
DATE OF 1 <sup>ST</sup> TREE ACTIVITY REPORT:	
CITY STAFF:	
/ERIFY THAT ALL TREE PROTECTION MEASURES AF ACTIVITY, SCHEDULED OR UNSCHEDULED, WITHIN	/ITY REPORT SHALL CONFORM TO SHEET T-1 FORMAT, RE IMPLIMENTED AND WILL INCLUDE ALL CONTRACTOR A TREE PROTECTION ROOT ZONE. NON-COMPLIANCE REFERENCE: PALO ALTO TREE TECHNICAL MANUAL,

Apply Tree Protection Report on sheet(s) T-2

Use additional "T" sheets as needed

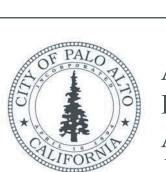

Special Tree Protection Instruction Sheet City of Palo Alto

