310-320 CALIFORNIA AVENUE

CONDITIONAL USE PERMIT PALO ALTO FIT & CAFE

CALIFORNIA AVE. PEDESTRIAN STREET LOCATION MAP ALMA ST TRAIN TRACK CAL AVE. TRAIN STATION PARK BLVD PARK BLYD PUBLIC PARKING GARAGE SITE PUBLIC PARKING GARAGE ASH ST MIMOSA LN PUBLIC PARKING GARAGE EL CAMINO REAL

PROJECT DATA

GENERAL INFORMATION

124-32-Ø34

ADDRESS: 310-320 CALIFORNIA AVENUE PALO ALTO, CA 94306

ZONING DISTRICT: FLOOD ZONE: HISTORIC CATEGORY:

EXISTING USE: 310 CALIFORNIA AVE: COMMERCIAL RECREATION

NONE

NONE

CC (2)(R)(P)

320 CALIFORNIA AVE: EATING AND DRINKING SERVICES

PROPOSED USE: NO CHANGE

CONSTRUCTION TYPE: Y-B

OCCUPANCY GROUP: PALO ALTO FIT: A-3 CAFE: A-2

SPRINKLER: (E) NONE

LOT SIZE: 12,000 S.F. (± 0.2755 ACRES)

BUILDING AREA

	EXISTING	PROPOSED
310 CALIFORNIA AVE.		
1ST FLOOR	5966 SF	7996 SF
2ND FLOOR	774 SF	2894 SF
TOTAL:	6740 SF	10890 SF

320 CALIFORNIA AVE.		
ENCLOSED OUTDOOR SEATING	400 SF	400 SF
1ST FLOOR	4434 SF	24Ø4 SF
2ND FLOOR	97Ø SF	N/A
TOTAL:	5804 SF	28Ø4 SF

TOTAL BUILDING FLOOR AREA		
1ST FLOOR	10800 SF	10800 SF
2ND FLOOR	1744 SF	2894 SF
TOTAL:	12544 SF	13694 SF
ADDITIONAL BUILDING FLOOR	115Ø SF	

TOTAL OFFICE AREA:

2983 SF

FAR: 1.14 (2.0:1 MAX ALLOWED)

SET BACKS: REQUIRED: 0-10' TO CREATE AN 8'-12' FRONT SET BACK

EFFECTIVE SIDEWALK WIDTH NOT REQUIRED INTERIOR SIDE YARD: STREET SIDE YARD: NOT REQUIRED REAR SIDE YARD: NOT REQUIRED

FRONT SET BACK: INTERIOR SIDE YARD: STREET SIDE YARD: REAR SIDE YARD:

PROVIDED: ±12" (NO CHANGE) ±6'-2" (NO CHANGE) ±2"(NO CHANGE) ±4'-0" (NO CHANGE)

REQUIRED: 37 FT MAX BUILDING HEIGHT: PROVIDED:25 FT (NO CHANGE)

NUMBER OF STORY:

PARKING CALCULATION:

		EXISTING	PROPOSED
COMMERCIAL	I SPACE FOR EACH 4 PERSON CAPACITY, OR AS ADJUSTED BY THE DIRECTOR AS PART OF A	123 OCCUPANTS	185 OCCUPANTS
RECREATION	CONDITIONAL USE PERMIT, NOT TO EXCEED 30% REDUCTION	31 REQUIRED	47 REQUIRED
EATING AND	I SPACE FOR EACH 60 GROSS SQFT OF PUBLIC SERVICE AREA, PLUS I SPACE FOR EACH 200 GROSS SQFT	AREA, 2614 OF OTHER, 1624 OF	1096 SF OF PUBLIC SERVICE AREA, 1708 SF OF OTHER
		69 REQUIRED	30 REQUIRED
	TOTAL:	100 REQUIRED	77 REQUIRED

PLUMBING CALCULATION:

310 CALIFORNIA AVE FIRST LEVEL								
	WA'	TER SET	URINAL	LAY	/A- RY	SHO	WER	DRINKING FOUNTAIN
	M	F		Y	щ	Σ	Ш	
TOTAL REQUIRED	1	3	1	1	1	-	-	1
TOTAL PROVIDED	2	3	1	2	2	2	2	1
310 CALIFORNIA AVE SECOND LEVEL								
	WA7 CLC	TER SET	URINAL	LA\ TO	/A- RY	SHO	WER	DRINKING FOUNTAIN
	M	F		Σ	Щ	Σ	Щ	
TOTAL REQUIRED	1	1	-	1	1	-	-	1
ALL GENDER PROVIDED	2	2	-	2	2	2	2	1

320 CALIFORNIA AVE.					
	WA'	TER	URINAL	LA	/A-
	S	SET	URINAL	TO	2 Y
	Σ	Щ		Σ	F
TOTAL REQUIRED	1	1	1	1	1
TOTAL PROVIDED	1	1	1	1	1
ALL GENDER PROVIDED		1	-	1	

PROJECT DESCRIPTION

THE PROJECT SCOPE CONSISTS OF A TENANT IMPROVEMENT FOR 310 CALIFORNIA AVE. FOR PALO ALTO FIT, A ONE-ON-ONE PERSONAL TRAINING SERVICE BUSINESS WITH NEW RESTROOMS, SHOWERS AND STAFF ROOMS. THE PROJECT PROPOSAL ADDS 1,150 SQ. FT. TO THE 2ND FLOOR OF THIS TENANT.

OPERATING STATEMENT:

PALO ALTO FIT (PAF) IS A PERSONAL TRAINING AND NUTRITION CONSULTING BOUTIQUE. OUR BUSINESS HOURS ARE FROM 6:00 AM TO 8:00 PM. ALL OUR SERVICES ARE APPOINTMENT-BASED ENSURING A PERSONALIZED EXPERIENCE FOR OUR CLIENTS. THE SPACE WILL BE PRIMARILY USED FOR FUNCTIONAL MOVEMENTS, MOBILITY EXERCISES, AND RESISTANCE TRAINING.

THE PROJECT ALSO INCLUDES A TENANT IMPROVEMENT FOR 320 CALIFORNIA AVE., RETAINING ITS CURRENT USE AS A CAFÉ/WINE BAR WITH NEW PUBLIC RESTROOMS.

NEITHER THERE ARE CHANGES PROPOSED TO THE BUILDING FOOTPRINT NOR TO THE BUILDING EXTERIOR.

THE PROJECT INTENTS TO KEEP THE THE EXISTING MURALS ON THE EAST AND SOUTH ELEVATIONS.

SHEET INDEX

ARCHITECTURAL:

ASO.0 TITLE SHEET

AREA CALCULATION AND CODE ANALYSIS

AS1.0 SITE PLAN

AS1.1 PHOTOS

AS2.0.1 EXISTING & DEMOLITION FIRST FLOOR PLAN

AS2.0.2 EXISTING & DEMOLITION SECOND FLOOR PLAN

AS2.1 PROPOSED IST FLOOR PLAN

AS2.2 PROPOSED 2ND FLOOR PLAN

AS2.3 ROOF PLAN

AS5.1 ELEVATIONS

AS6.0 EXISTING SECTIONS

AS6.1 PROPOSED SECTIONS

T-1 SPECIAL TREE PROTECTION INSTRUCTION SHEET

PROJECT TEAM

OWNER

MIRCO HORST & NINA NGUYEN Phone: (408) 412-2661 Contact: MIRCO HORST & NINA NGUYEN

3261 ASH STREET, SUITE A PALO ALTO, CA 94306 Email: mircohorst@me.com

ARCHITECT

PALO ALTO, CA 94301


KO ARCHITECTS, INC. 900 HIGH STREET, STE.

Phone: (650) 853-1908 Contact: PETER KO, AIA

Email: designakoarch.com

nina@paloaltofit.com

VICINITY MAP

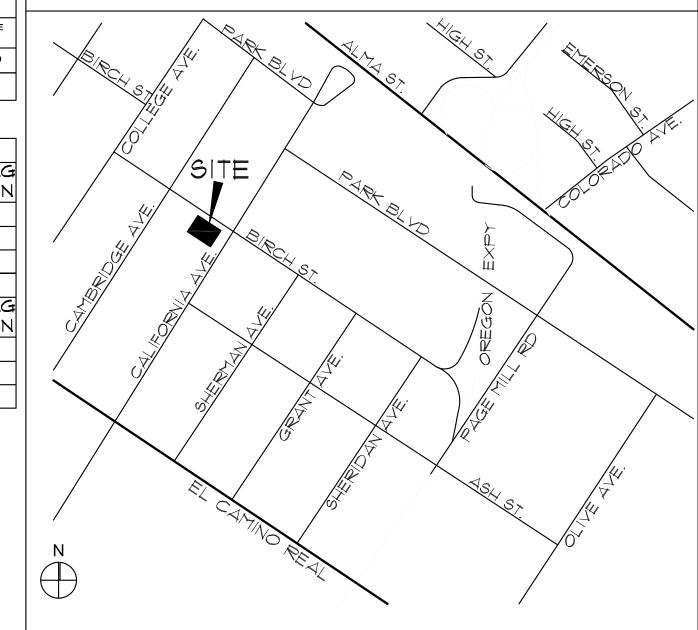

310-320 CALIFORNIA AVE. INTERIOR TENANT **IMPROVEMENT**

310-320 CALIFORNIA AVE., PALO ALTO, CA 94306



Ko Architects, Inc. 900 High Street, Suite 1 Palo Alto, CA 94301 f: 650.853.1845




REVISION	
CUP SUBMITTAL	11.02.2023
CUP IST RESUBMITTAL	Ø1.19.2 <i>0</i> 24

PROJECT NO.	23-31
DATE	AUG 202
DRAWN BY	LC
SCALE	AS NOTE

TITLE SHEET

SHEET


AS0.0

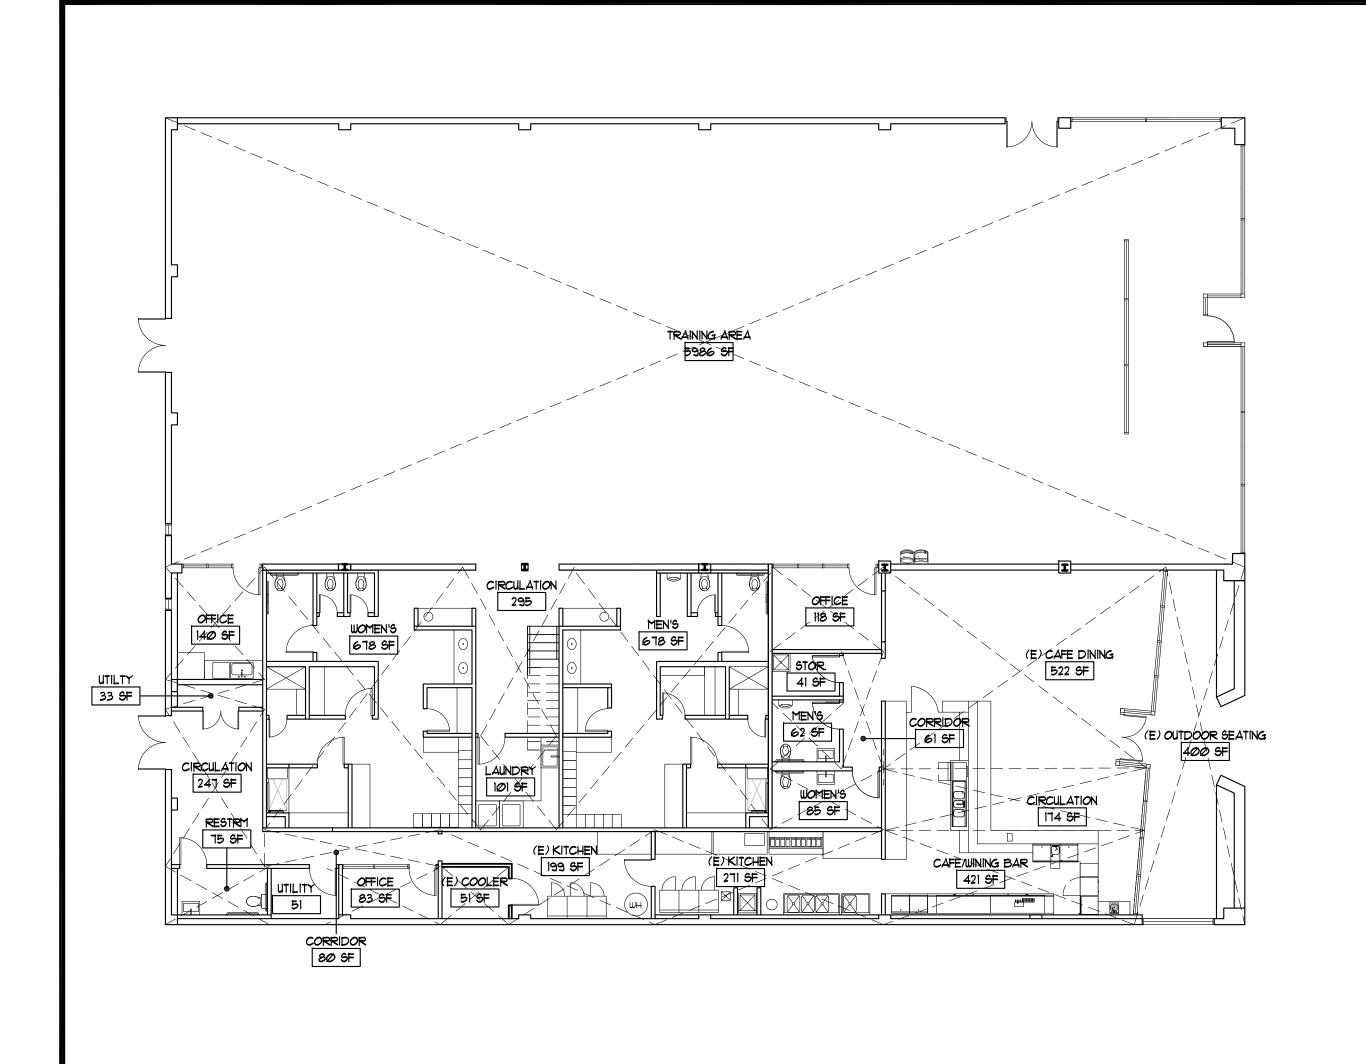

310 CALIFORI FIRST FLOOR				
ROOM NAME	AREA	OCC. TYPE	OCC. LOAD FACTOR	OCC. LOAD
TRAINING AREA	5986 SF	A-3	50	120
WOMEN'S ROOM	678 SF	A-3	5Ø	14
MEN'S ROOM	678 SF	A-3	5Ø	14
OFFICE	118 SF	В	150	1
OFFICE	140 SF	В	150	1
LAUNDRY	1Ø1 SF	S -2	300	1
CIRCULATION	295 SF			
TOTAL:	7996 SF			151

TOTAL:	7996 SF			151
320 CALIFOR	NIA AVE			
ROOM NAME	AREA	OCC. TYPE	OCC. LOAD FACTOR	OCC. LOAD
(E) CAFE DINING	522 SF	A-2	15	35
CIRCULATION	174 SF			
CAFE/WINE BAR	421 SF	A-2	200	3
(E) KITCHEN	271 SF	A-2	200	2
(E) KITCHEN	199 SF	A-2	200	1
WOMEN'S	85 SF	A-2	50	2
MEN'S	62 SF	A-2	50	2
CORRIDOR	61 SF			
(E) COOLER	51 SF	S- 2	200	1
OFFICE	83 SF	В	150	1
UTILITY	51 SF	S- 2	300	1
RESTROOM	75 SF	A-2	50	2
CORRIDOR	80 SF			
UTILITY	33 SF	S- 2	300	1
CIRCULATION	236 SF			
OUTDOOR SEATING	400 SF			
TOTAL:	28Ø4 SF			51

PROPOSED FIRST FLOOR PLAN 3/32"=1 PROPOSED FIRST FLOOR AREA & OCC. CALCULATION

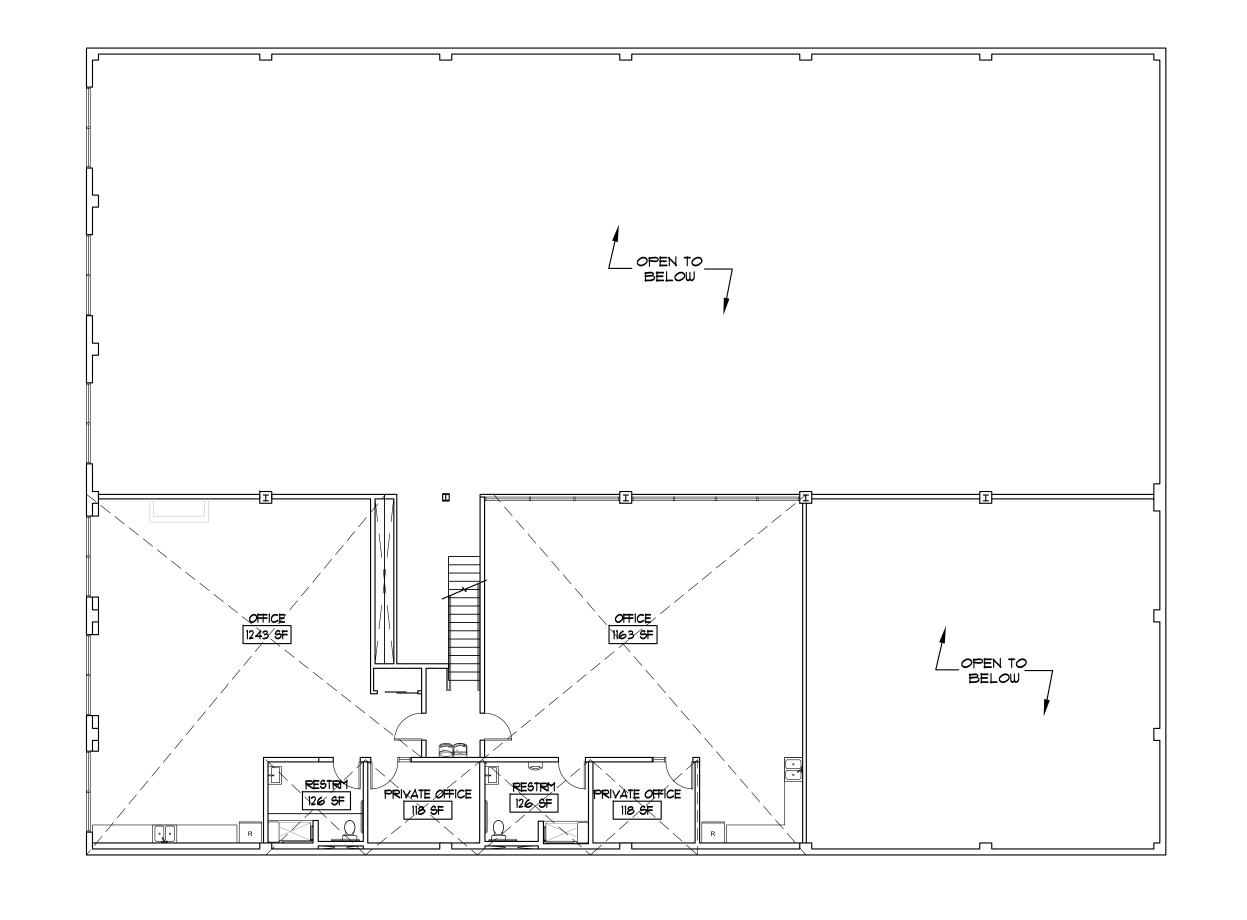

PROPOSED SECOND FLOOR PLAN |3/32"=1" 2

	1 ADE A	occ.	OCC. LOAD	OCC.
ROOM NAME	AREA	TYPE	FACTOR	LOAD
OFFICE	1243 SF	В	150	9
OFFICE	1163 SF	B	50	21
RESTROOM	126 SF	B	15Ø	1
RESTROOM	126 SF	B	150	1
OFFICE	118 SF	B	15Ø	1
OFFICE	118 SF	В	150	1

PROPOSED SECOND FLOOR AREA & OCC. CALCULATION

	PROPOSED
310 CALIFORNIA AVE.	
16T FLOOR	7996 SF
2ND FLOOR	2894 SF
TOTAL:	10890 SF
320 CALIFORNIA AVE.	
ENCLOSED OUTDOOR SEATING	400 SF
1ST FLOOR	24Ø4 SF
2ND FLOOR	N/A
TOTAL:	28Ø4 SF
TOTAL BUILDING FLOOR AREA	10000 65
1ST FLOOR	10800 SF
2ND FLOOR	2894 SF
TOTAL:	13694 SF

· · · ·	
PROPOSED FAR:	13694 SF / 12000 SF = 1.14

	OFFICE AREA	
	EXISTING	PROPOSED
310 CALIFORNIA AVE.	1740 SF	2900 SF
320 CALIFORNIA AVE.	1348 SF	83 SF
TOTAL:	3 0 88 SF	2983 SF

AREA SUMMARY

CONSTRUCTION TYPE: SPRINKLER: (E) NONE

		ALLOWABLE BUILDING HEIGHT ABOVE GRADE PLANE PER CBC TABLE 504.3	ALLOWABLE NUMBER OF STORIES ABOVE GRADE PLANE TABLE 504.4	ALLOWABLE AREA FACTOR PER TABLE 506.2
RAINING AREA	A-3	40 FT	1	6000 SF
CAFE	A-2	40 FT	1	6000 SF
PFICE	В	40 FT	1	9000 SF

MOST RESTRICTIVE: A-3 & A-2, 1 STORY, 6000 SF

FRONTAGE INCREASE FACTOR PER TABLE 506.3.3 WITH 50-75 PERCENT OF BUILDING PERIMETER HAVING 25-30 FEET OPEN SPACE, THE AREA INCREASE FACTOR IS 0.42.

MAXIMUM ALLOWABLE AREA WITH FRONTAGE AREA INCREASE

A-3/A-2: (6000 + 6000 \times 0.42) = 8520 SF B: (9000 + 9000 × 0.42) = 12780 SF

USING SEPARATED OCCUPANCY METHOD BETWEEN 310 AND 320 CALIFORNIA

310 CALIFORNIA: PROPOSED AREAS (PER FLOOR)
1ST STORY: A-3 = 1996 SF
2ND STORY: B = 2894 SF

320 CALIFORNIA: PROPOSED AREAS (PER FLOOR)
1ST STORY: A-2 = 2404 SF

<u>RATIO CHECK (PER FLOOR)</u> 1ST FLOOR: 1996/8520 = 0.94 < 1 2ND FLOOR: 2894/12180 = 0.23 < 1


OCCUPANCY SEPARATION PER TABLE 508.4


BETWEEN OCCUPANCY A AND B:


FIRE WALL RATING PER TABLE 106.4 FOR OCCUPANCY IN A AND B IN TYPE V:

2 HOUR SEPARATION REQUIRED

2 HOUR SEPARATION REQUIRED

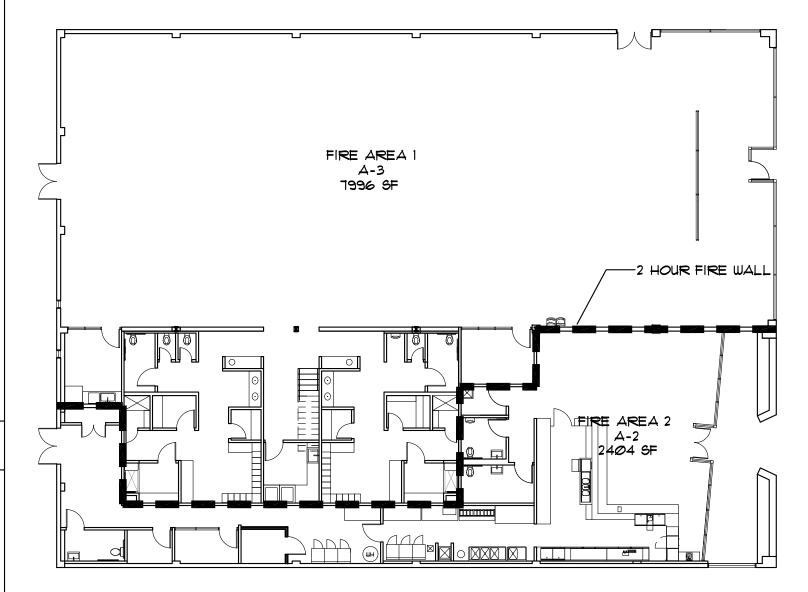

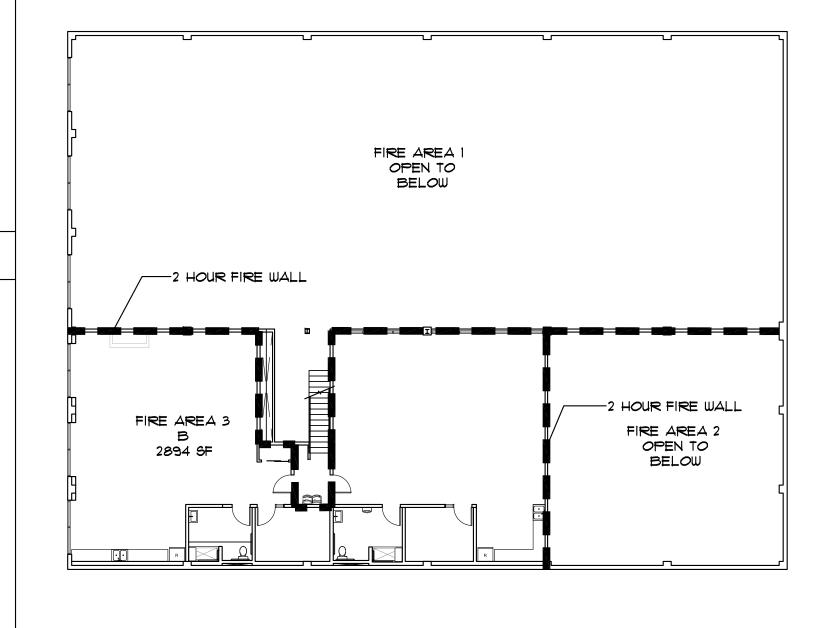

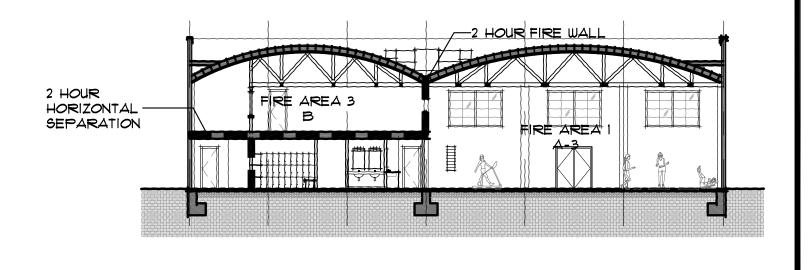

CODE ANALYSIS

310-320 CALIFORNIA AVE. **INTERIOR TENANT IMPROVEMENT**

310-320 CALIFORNIA AVE., PALO ALTO, CA 94306




Ko Architects, Inc. 900 High Street, Suite 1 Palo Alto, CA 94301 f: 650.853.1845



CUP SUBMITTAL	11.02.2023
CUP IST RESUBMITTAL	Ø1.19.2 <i>0</i> 24

PROJECT NO.	23-31
DATE	AUG 202
DRAWN BY	C
SCALE	AS NOTE

SHEET **AREA** CALCULATION & ASO.1 **ANALYSIS**

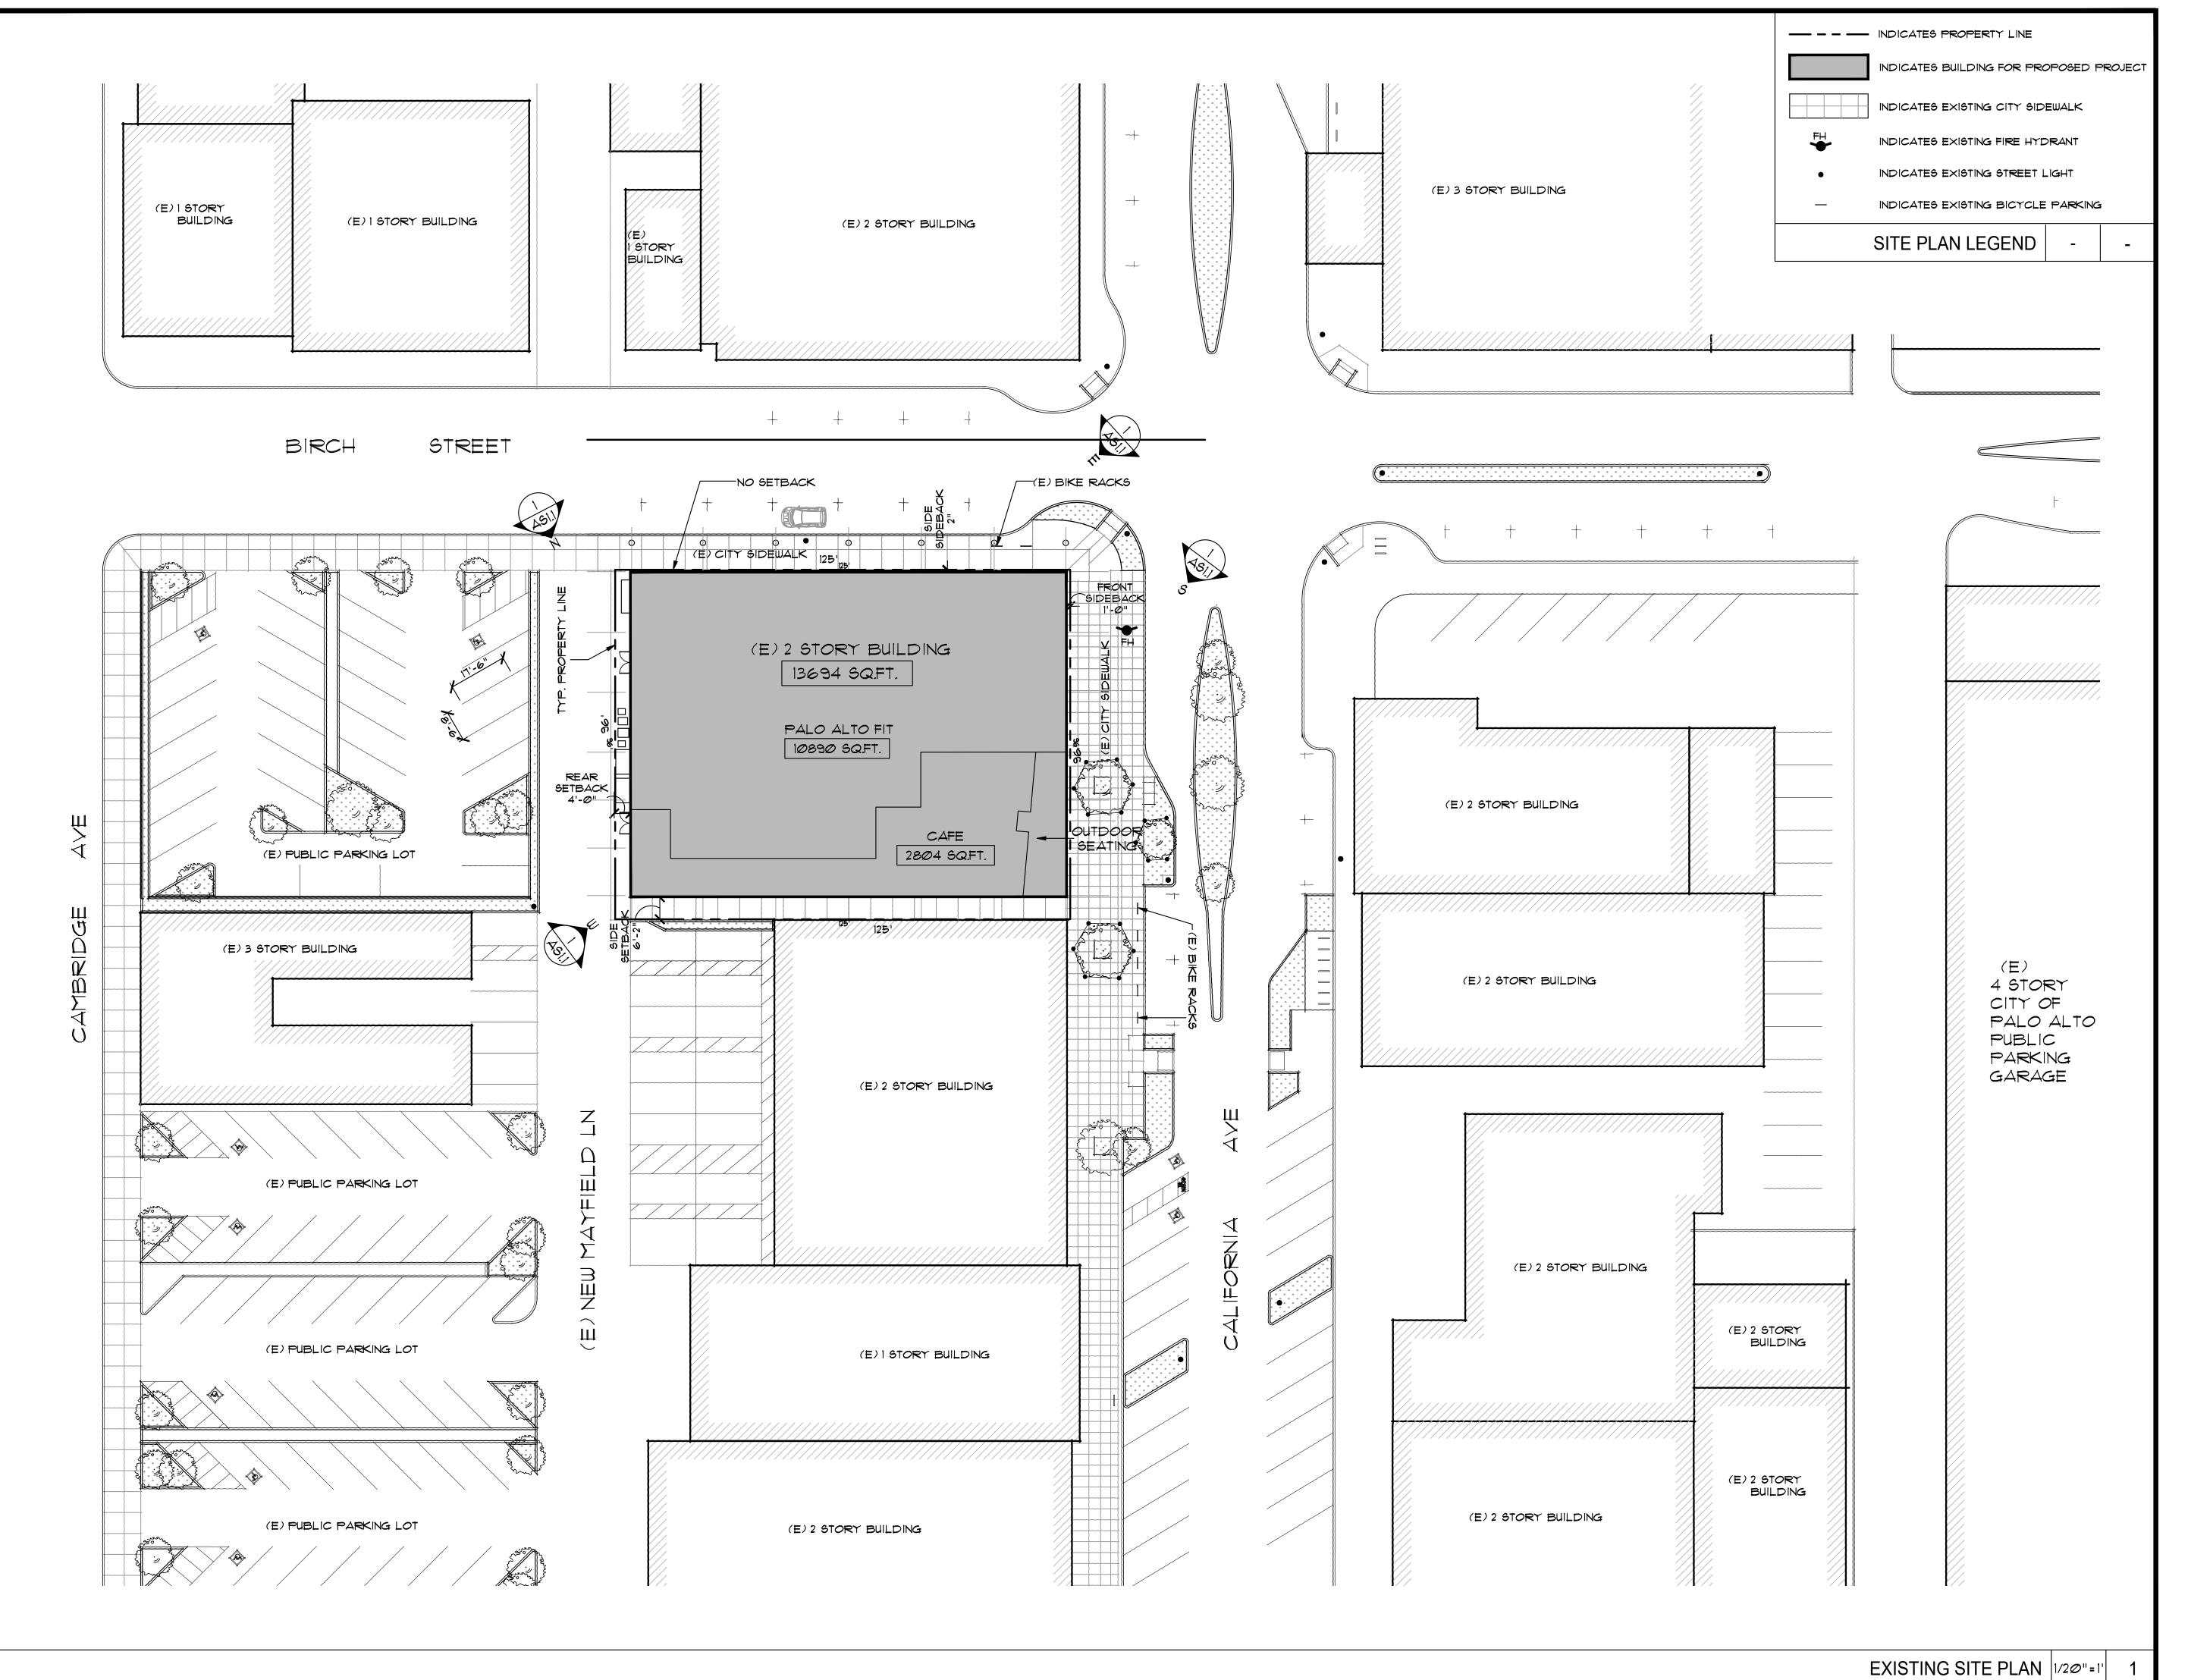

310-320 CALIFORNIA AVE., PALO ALTO, CA 94306



Ko Architects, Inc. 900 High Street, Suite 1
Palo Alto, CA 94301
p: 650.853.1908
f: 650.853.1845



CUP SUBMITTAL	11.02.2023
CUP 19T RESUBMITTAL	Ø1.19.2 <i>0</i> 24
_	

DATE AUG 2023

DRAWN BY SD

SCALE AS NOTED

EXISTING SITE PLAN SHEET

AS1.0




A SOUTH ELEVATION







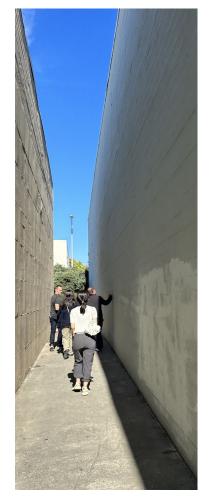

E WEST ELEVATION- VIEW FROM CALIFORNIA AVE.

310-320 CALIFORNIA AVE., PALO ALTO, CA 94306

310-320

CALIFORNIA AVE.

INTERIOR TENANT

IMPROVEMENT







B EAST ELEVATION AND MURAL


(C) NORTH ELEVATION

(D) WEST ELEVATION- VIEW FROM REAR PARKING LOT

EXISTING EXTERIOR ELEVATIONS

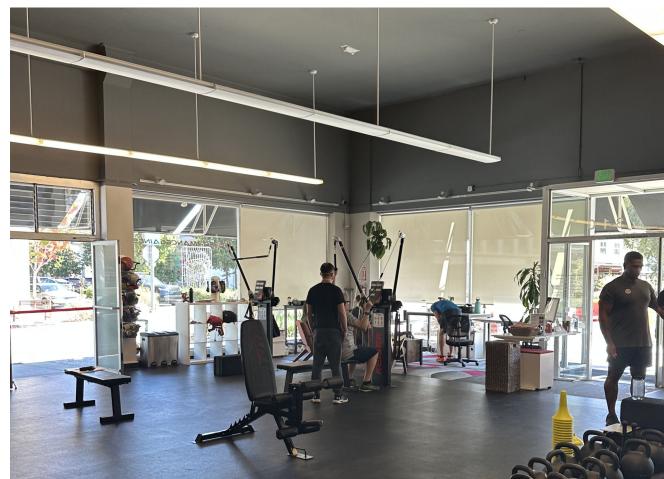

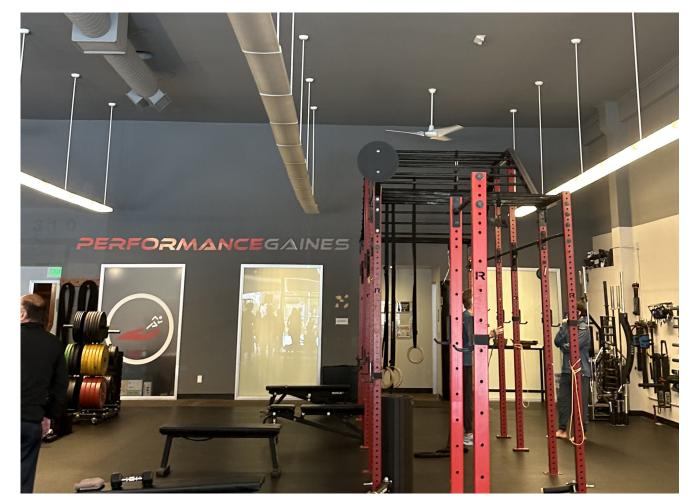

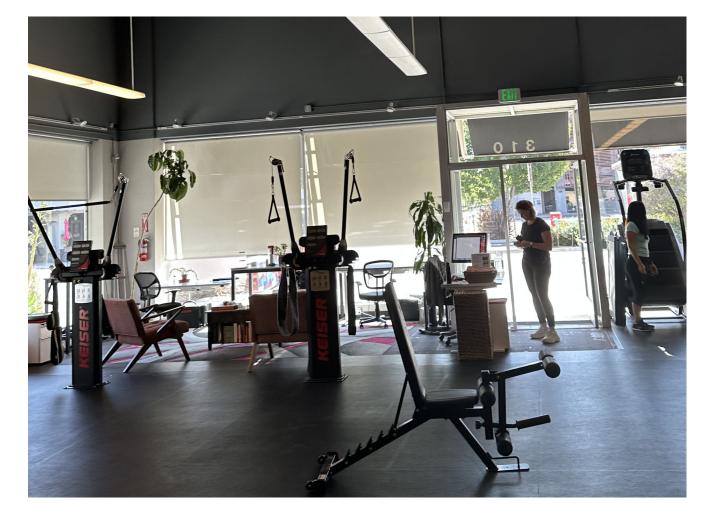

(|) ENTRANCE




G RECEPTION

(H) TRAINING SPACE


EXISTING TENANT 1 - 310 CALIFORNIA AVE.



J CAFE

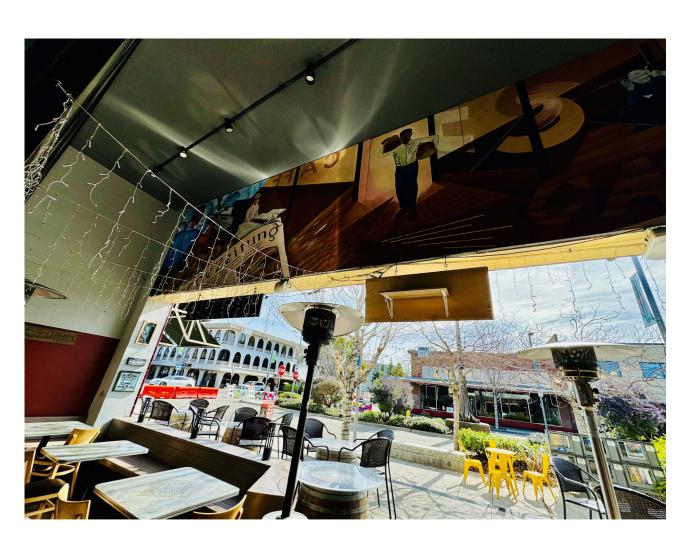



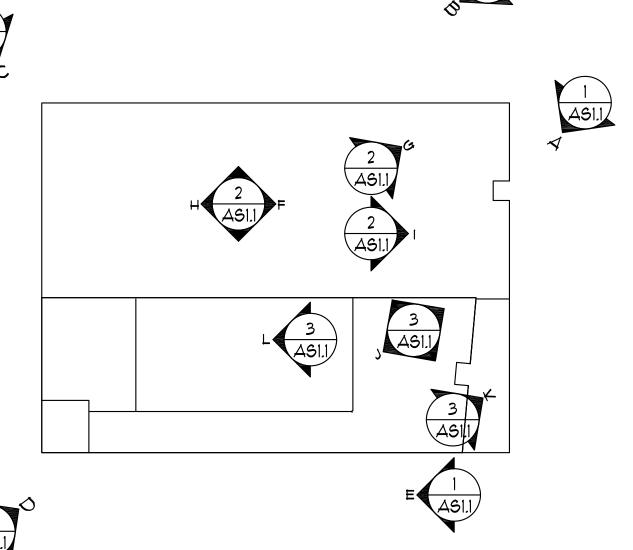

K CAFE MURAL

ART GALLERY

EXISTING TENANT 2 - 320 CALIFORNIA AVE.

EXISTING BUILDING PHOTOS


CUP SUBMITTAL


CUP IST RESUBMITTAL

SHEET **AS1.1**

11.02.2023

Ø1.19.2Ø24

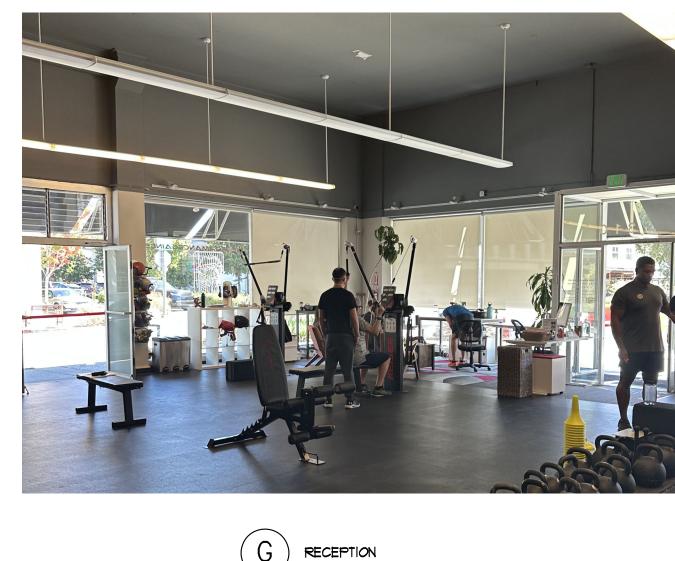

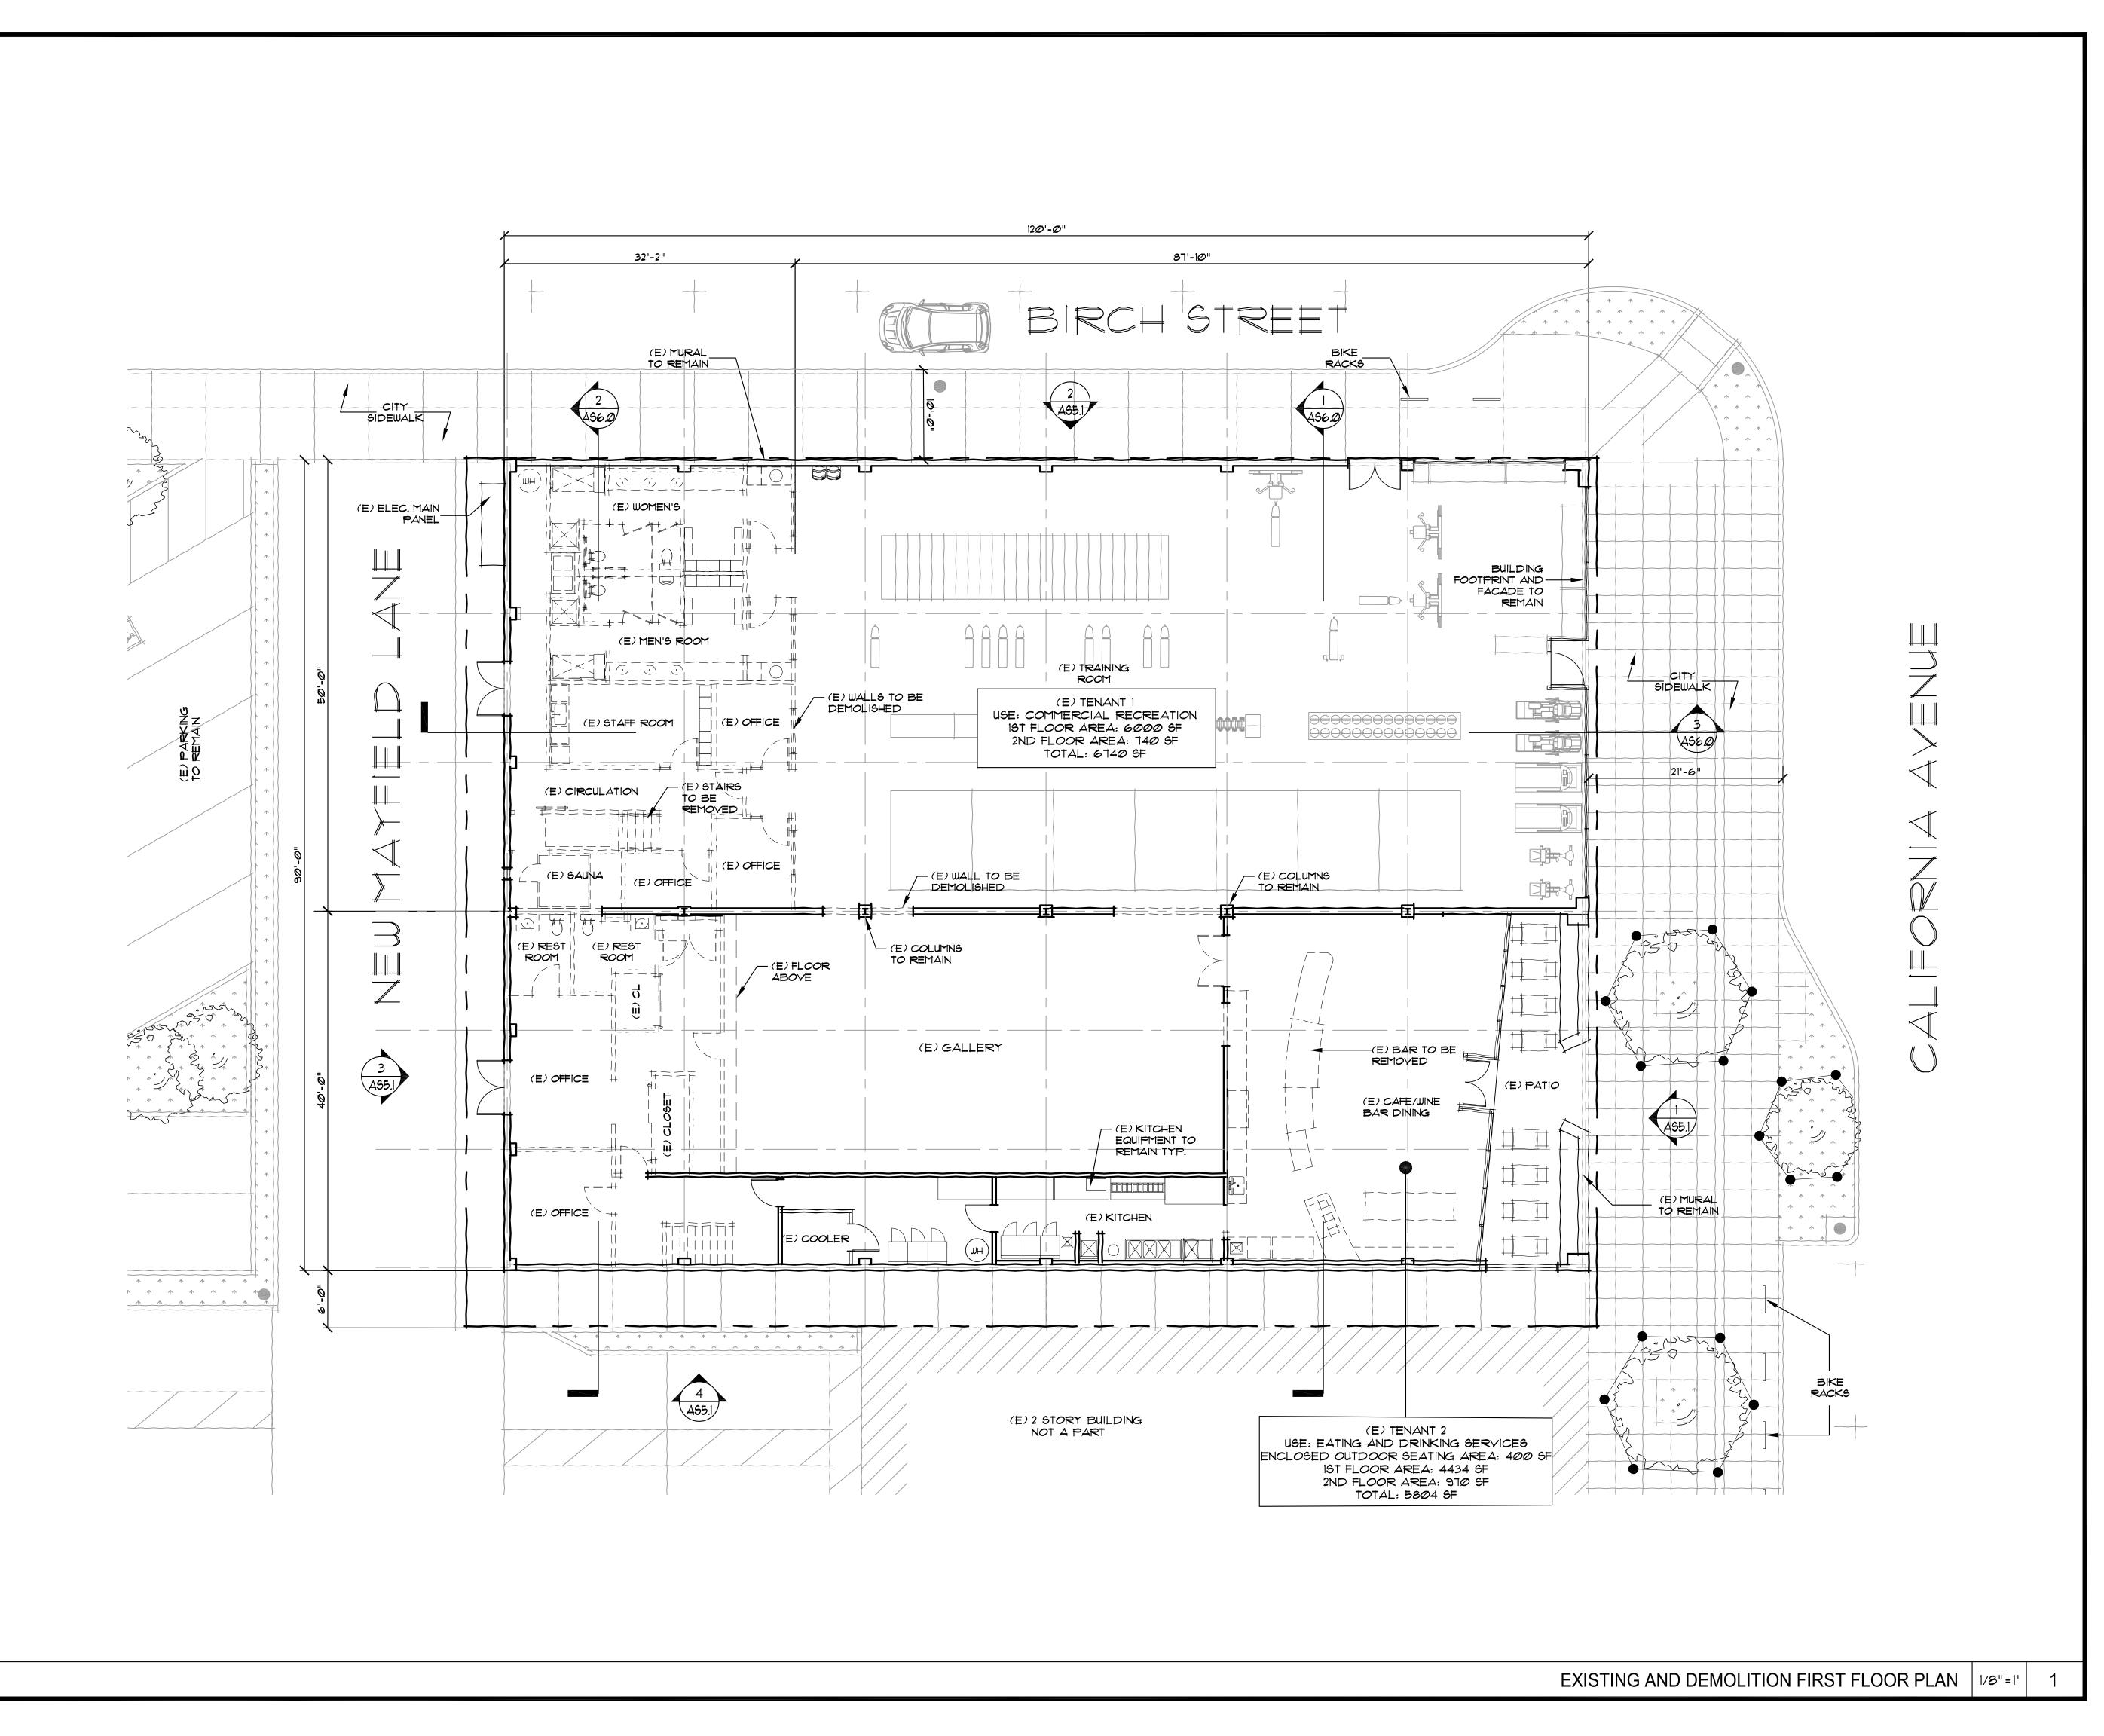

310-320 CALIFORNIA AVE., PALO ALTO, CA 94306



Ko Architects, Inc. 900 High Street, Suite 1 Palo Alto, CA 94301 p: 650.853.1908 f: 650.853.1845



CUP SUBMITTAL	11.02.202
CUP IST RESUBMITTAL	Ø1.19.2024

REF. NORTH	

PROJECT NO. 23-310


DATE AUG 2023

DRAWN BY CZ

SCALE AS NOTED

EXISTING AND DEMOLITION FIRST FLOOR PLAN

SHEET
AS2.0.

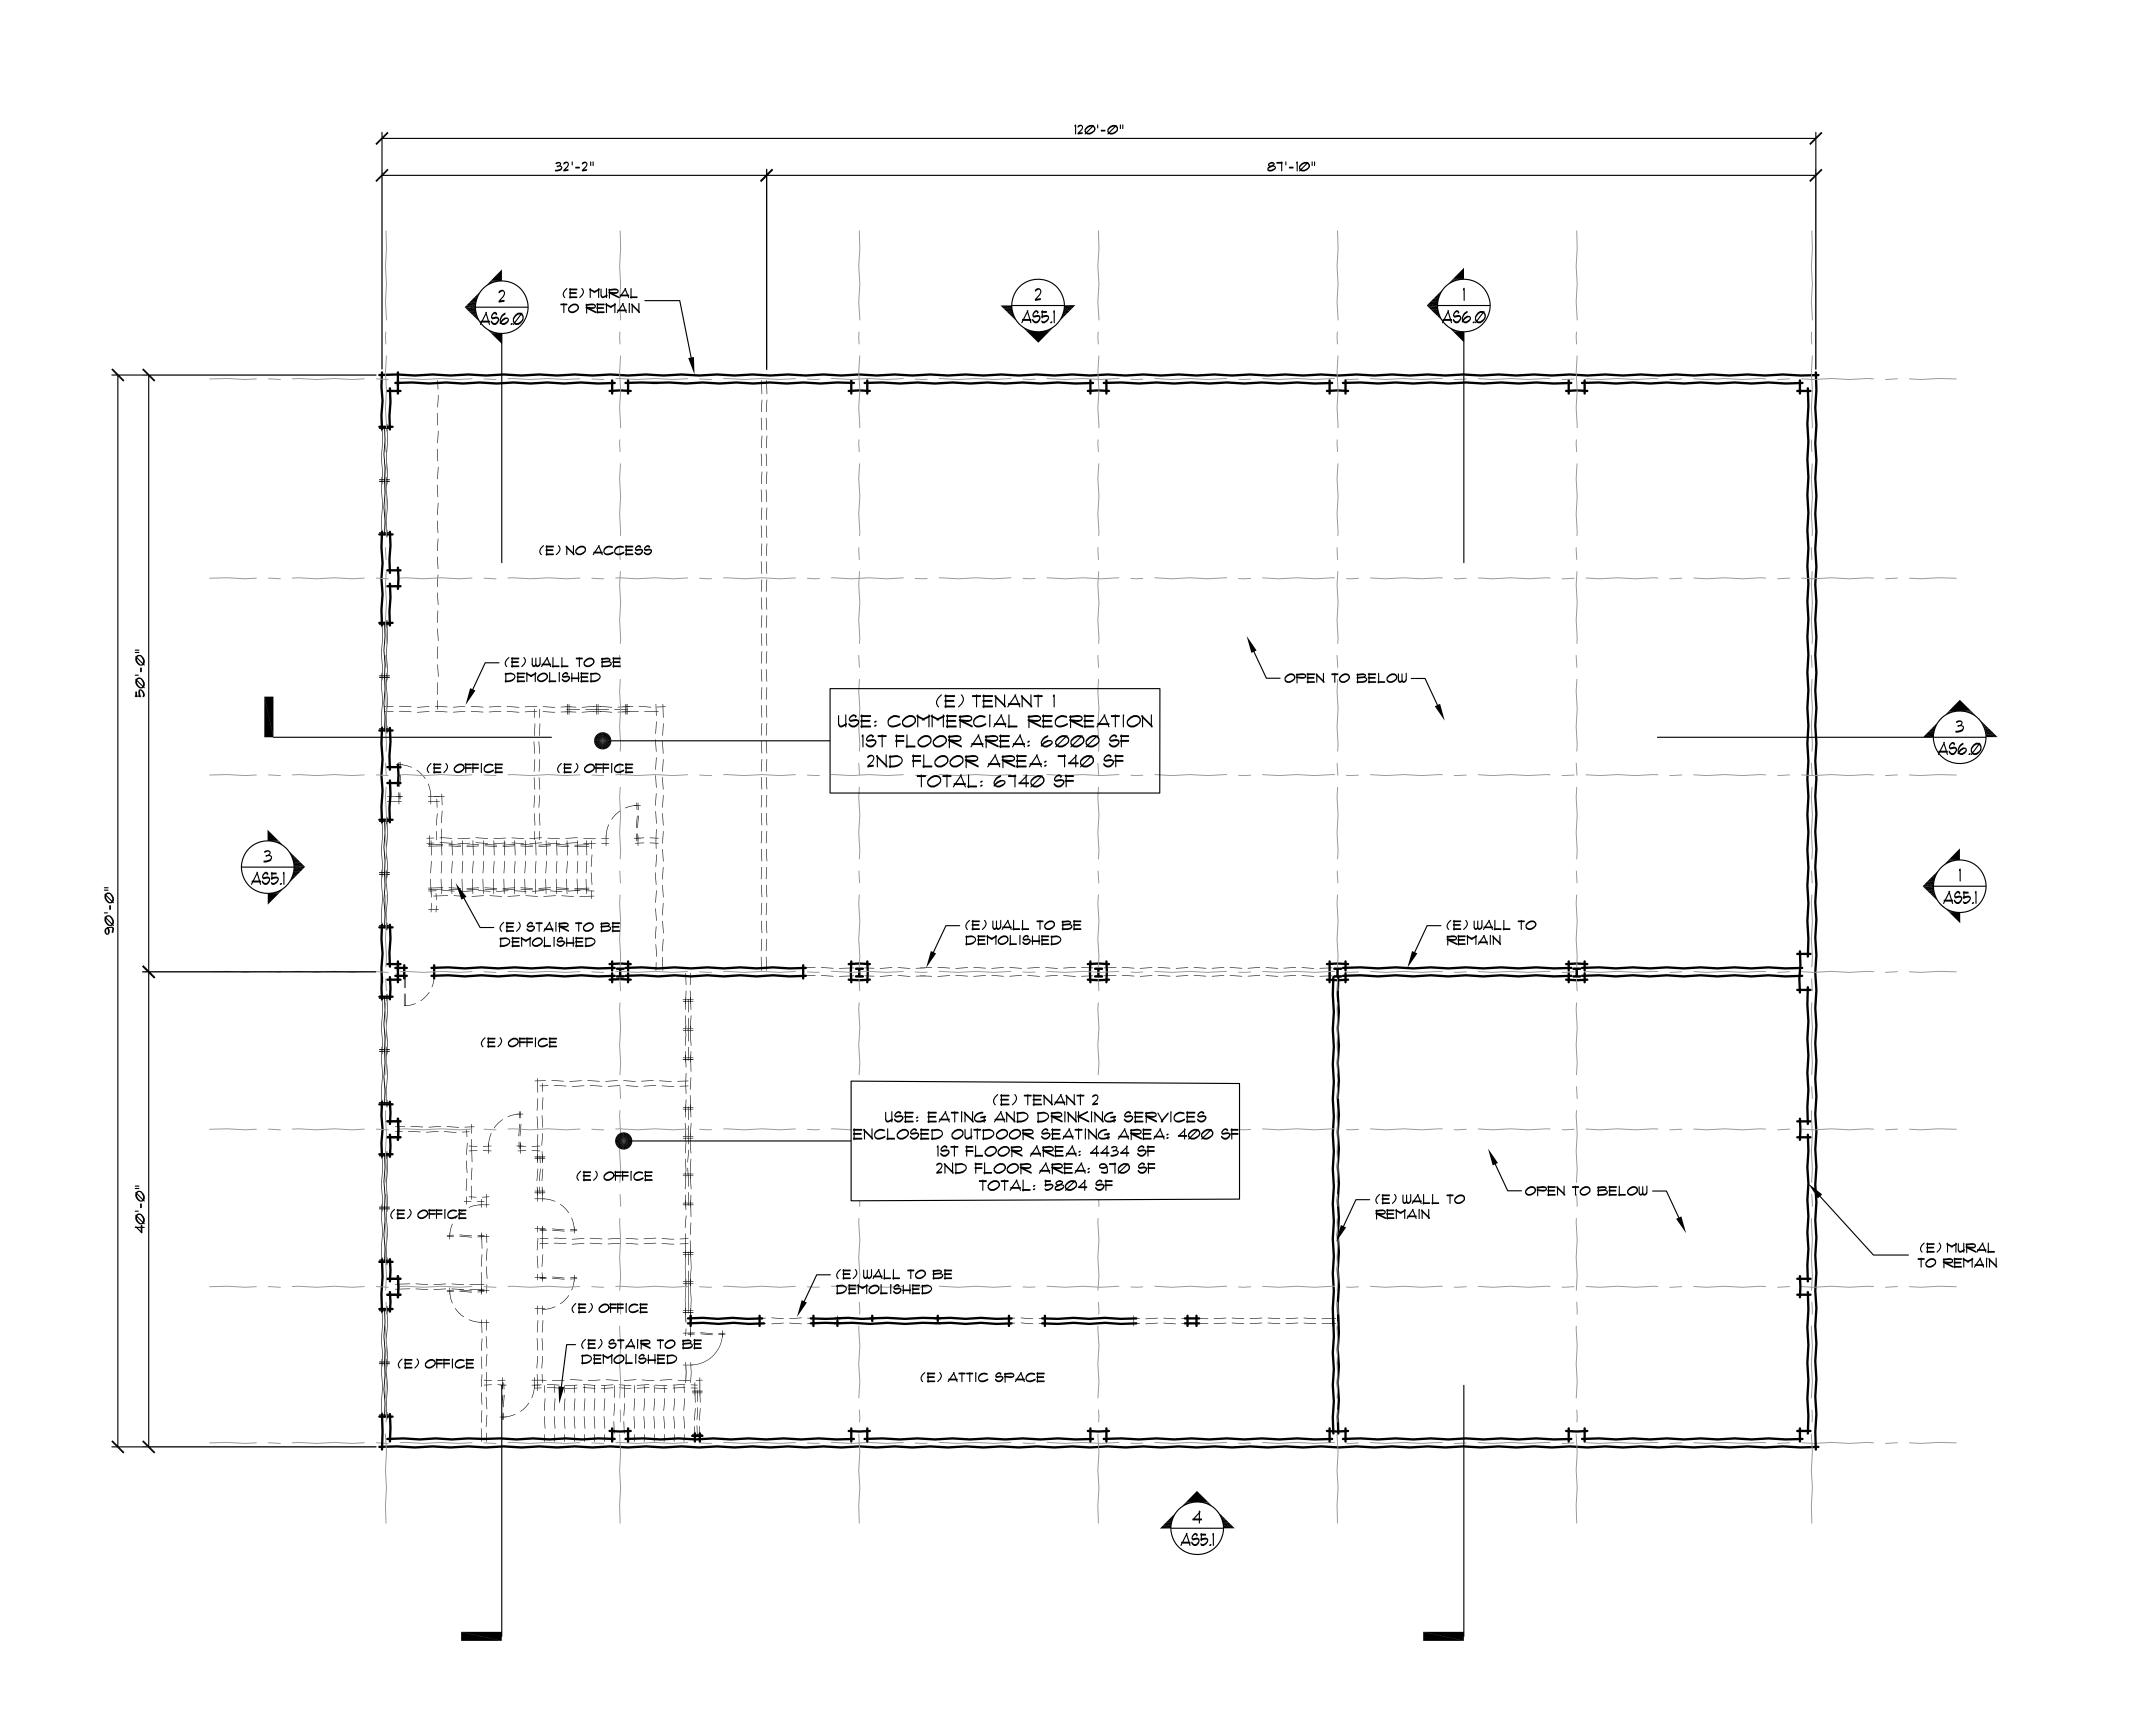

310-320 CALIFORNIA AVE., PALO ALTO, CA 94306



Ko Architects, Inc. 900 High Street, Suite 1 Palo Alto, CA 94301 p: 650.853.1908 f: 650.853.1845




CUP SUBMITTAL	11.02.202
CUP IST RESUBMITTAL	Ø1.19.2Ø2

F.	NORTH	
		_
		_
		_

PROJECT NO.	23-310
DATE	AUG 2023
DRAWN BY	CZ
SCALE	AS NOTED

EXISTING AND DEMOLITION SECOND FLOOR PLAN

AND SHEET ON AS2.0.

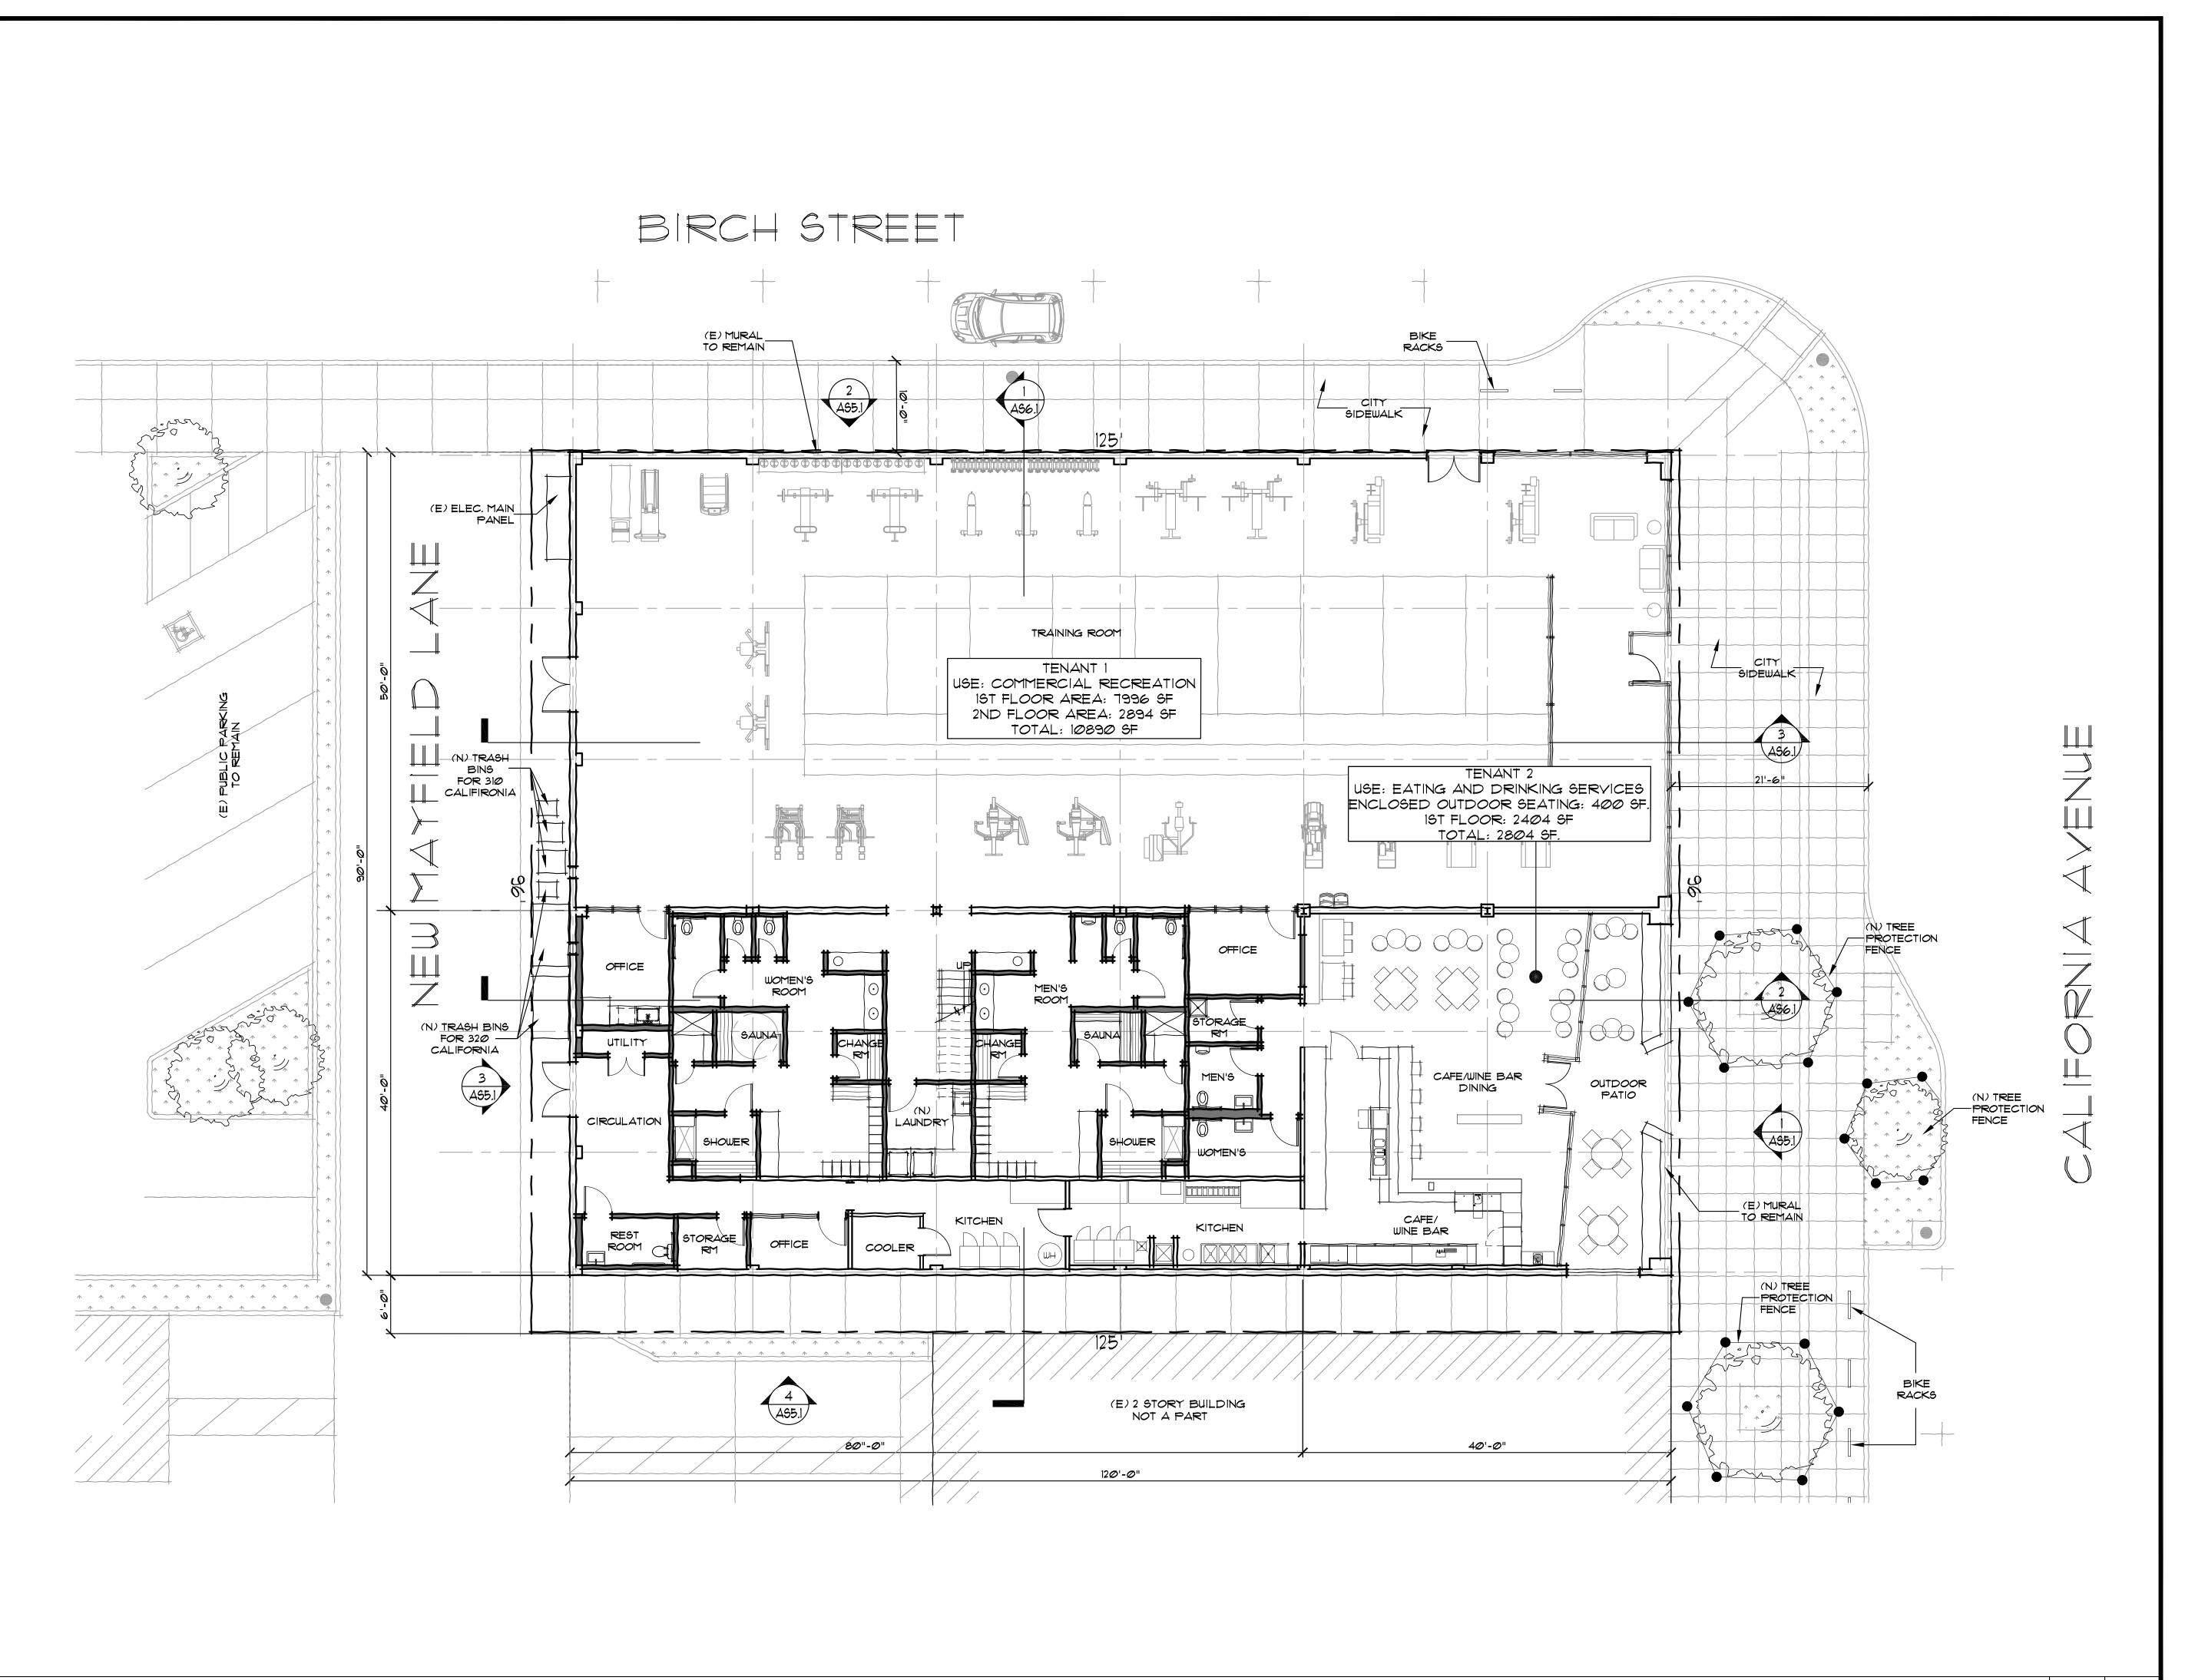

310-320 CALIFORNIA AVE., PALO ALTO, CA 94306



Ko Architects, Inc. 900 High Street, Suite 1 Palo Alto, CA 94301 p: 650.853.1908 f: 650.853.1845




CUP SUBMITTAL	11.02.2023
CUP IST RESUBMITTAL	Ø1.19.2 <i>0</i> 24

REF. NORTH	
	\ /

PROJECT NO.	23-310
DATE	AUG 2023
DRAWN BY	C
SCALE	AS NOTE

PROPOSED FIRST

SHEET FLOOR PLAN AS2.1

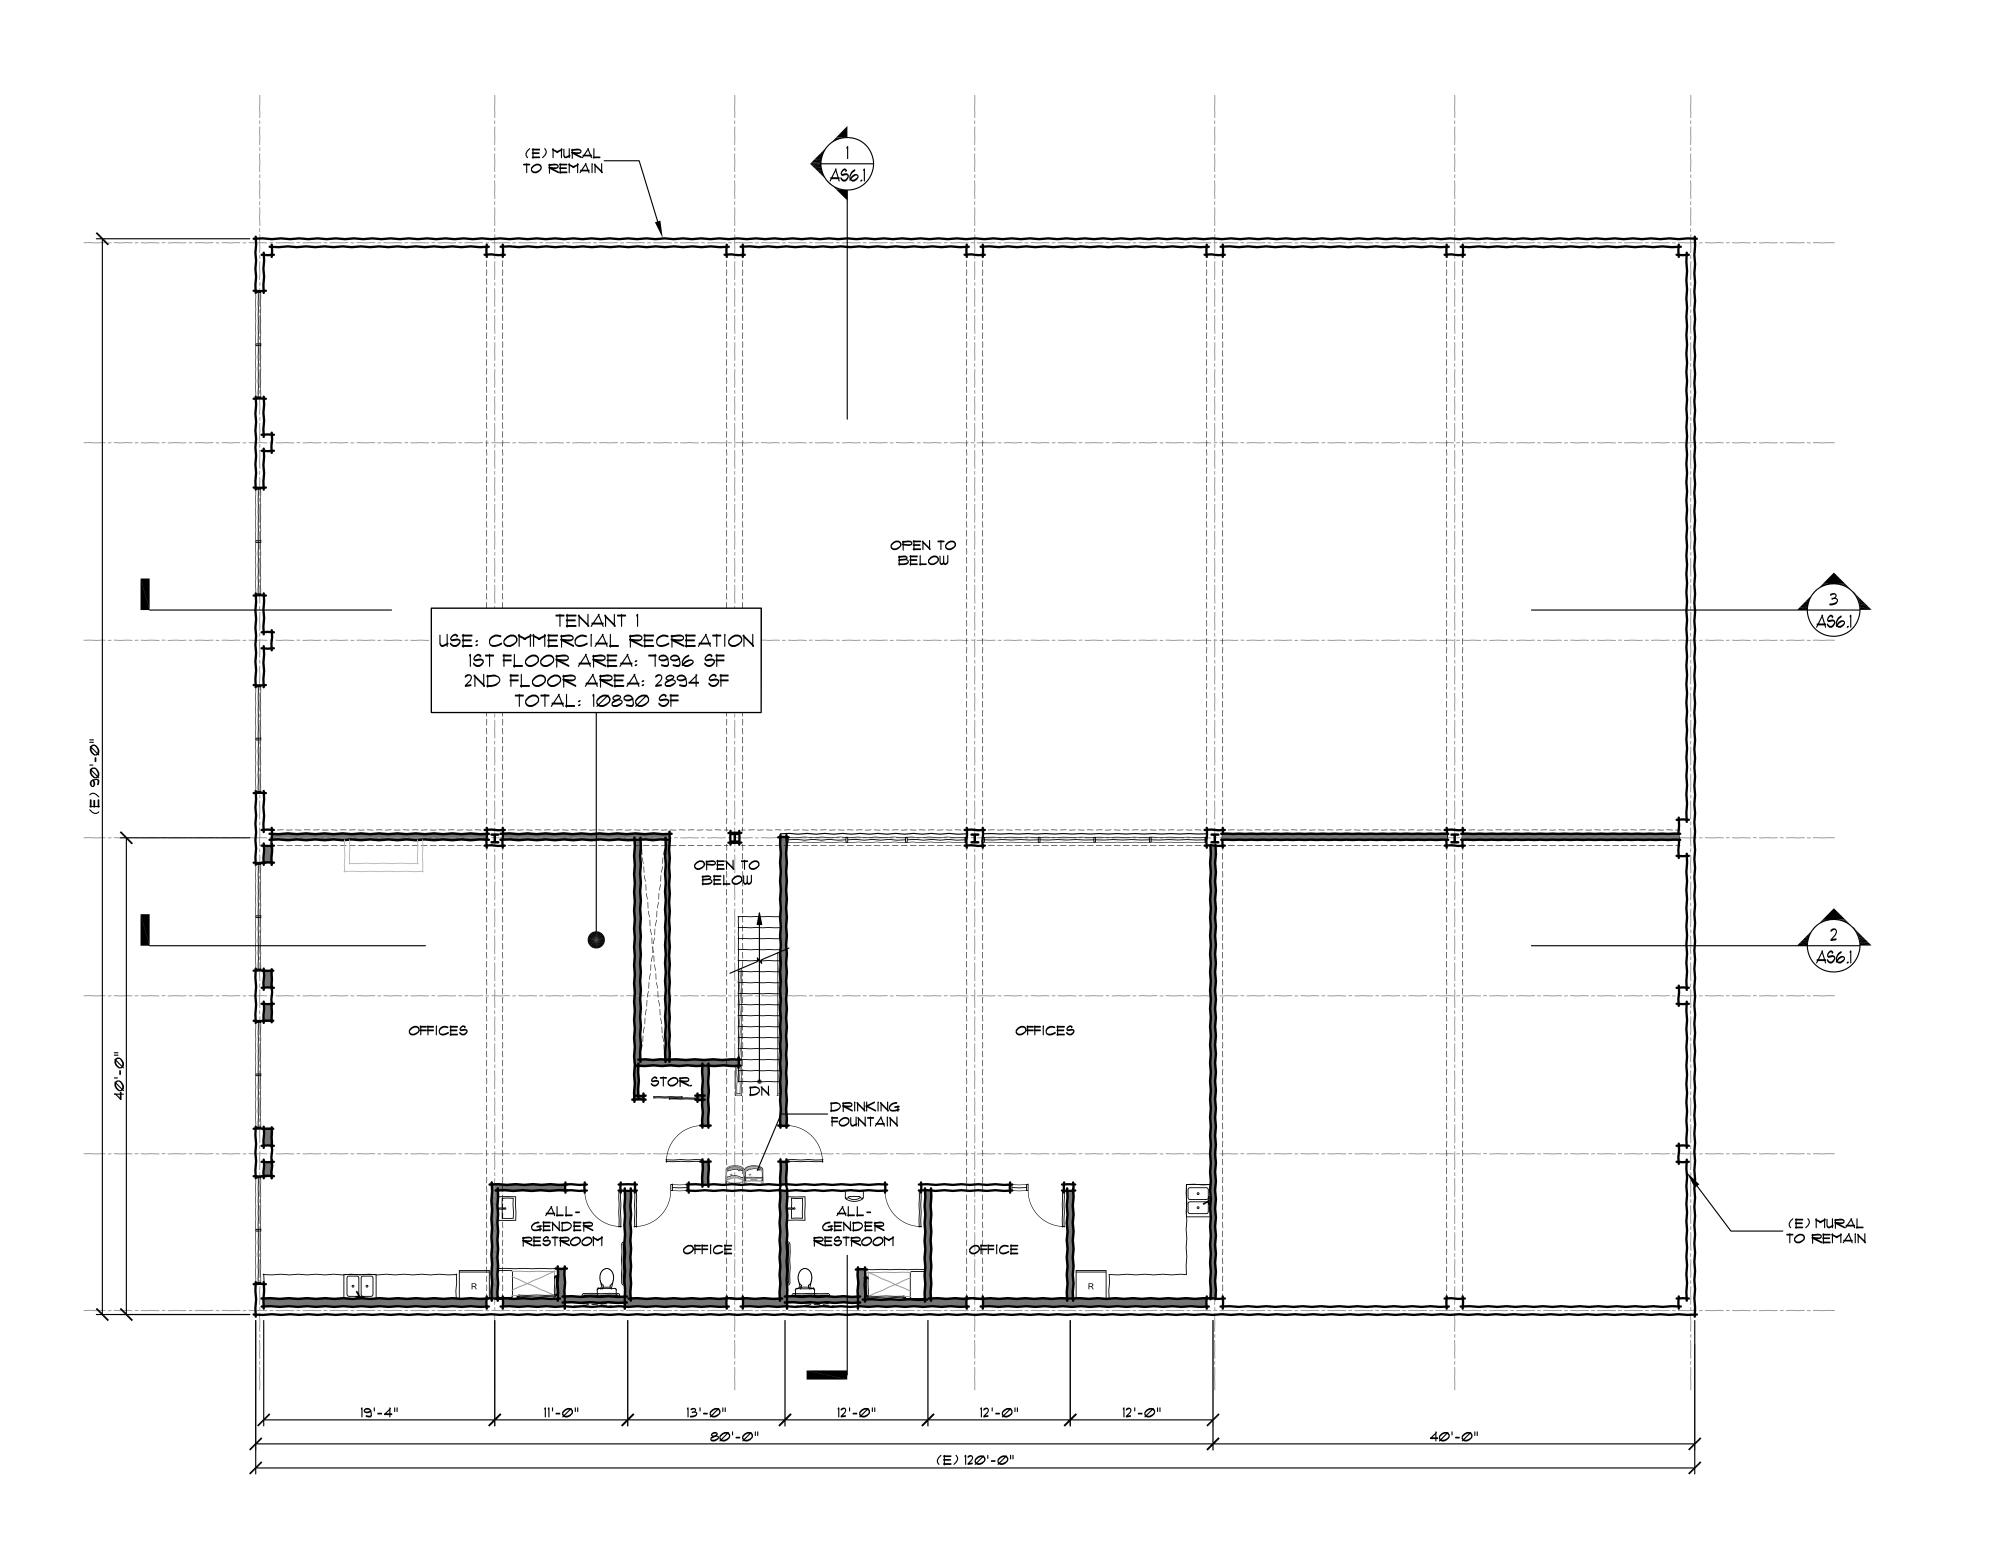

310-320 CALIFORNIA AVE., PALO ALTO, CA 94306



Ko Architects, Inc. 900 High Street, Suite 1
Palo Alto, CA 94301
p: 650.853.1908
f: 650.853.1845




CUP SUBMITTAL	11.02.2023
CUP IST RESUBMITTAL	Ø1.19.2 <i>0</i> 24

F. NORTH	PRC
	DAT
	DRA
	SCA

PROJECT NO.	23-310
DATE	AUG 2023
DRAWN BY	EC
SCALE	AS NOTED
<u> </u>	

PROPOSED SECOND

SHEET FLOOR PLAN AS2.2

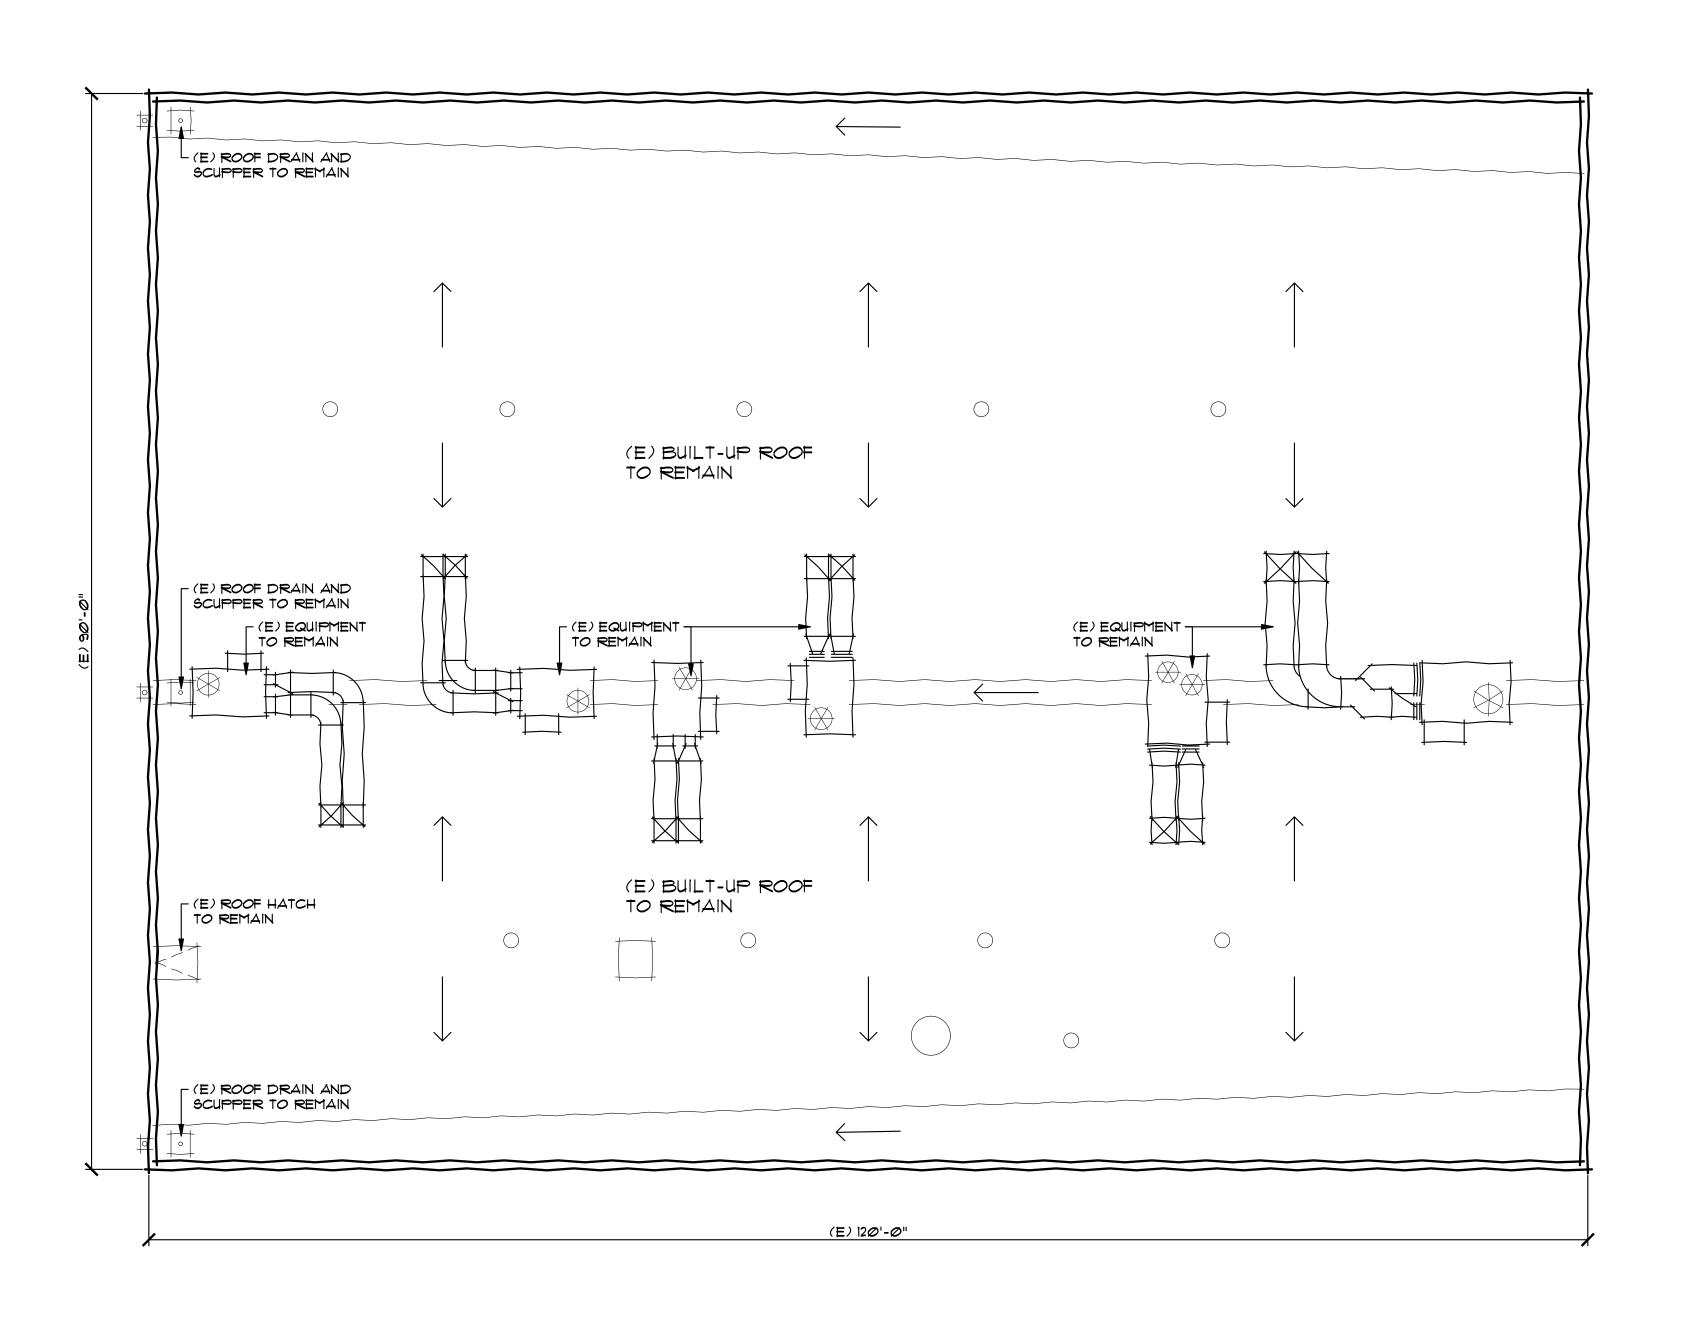

310-320 CALIFORNIA AVE., PALO ALTO, CA 94306



Ko Architects, Inc. 900 High Street, Suite 1 Palo Alto, CA 94301 p: 650.853.1908 f: 650.853.1845



CUP SUBMITTAL	11.02.2023
CUP IST RESUBMITTAL	Ø1.19.2 <i>0</i> 24

EF. NORTH	PROJECT NO.
	DATE
	DRAWN BY
	SCALE
Y /	•

DATE AUG 2023


DRAWN BY EC

SCALE AS NOTED

SHEET

ROOF PLAN

AS2.3

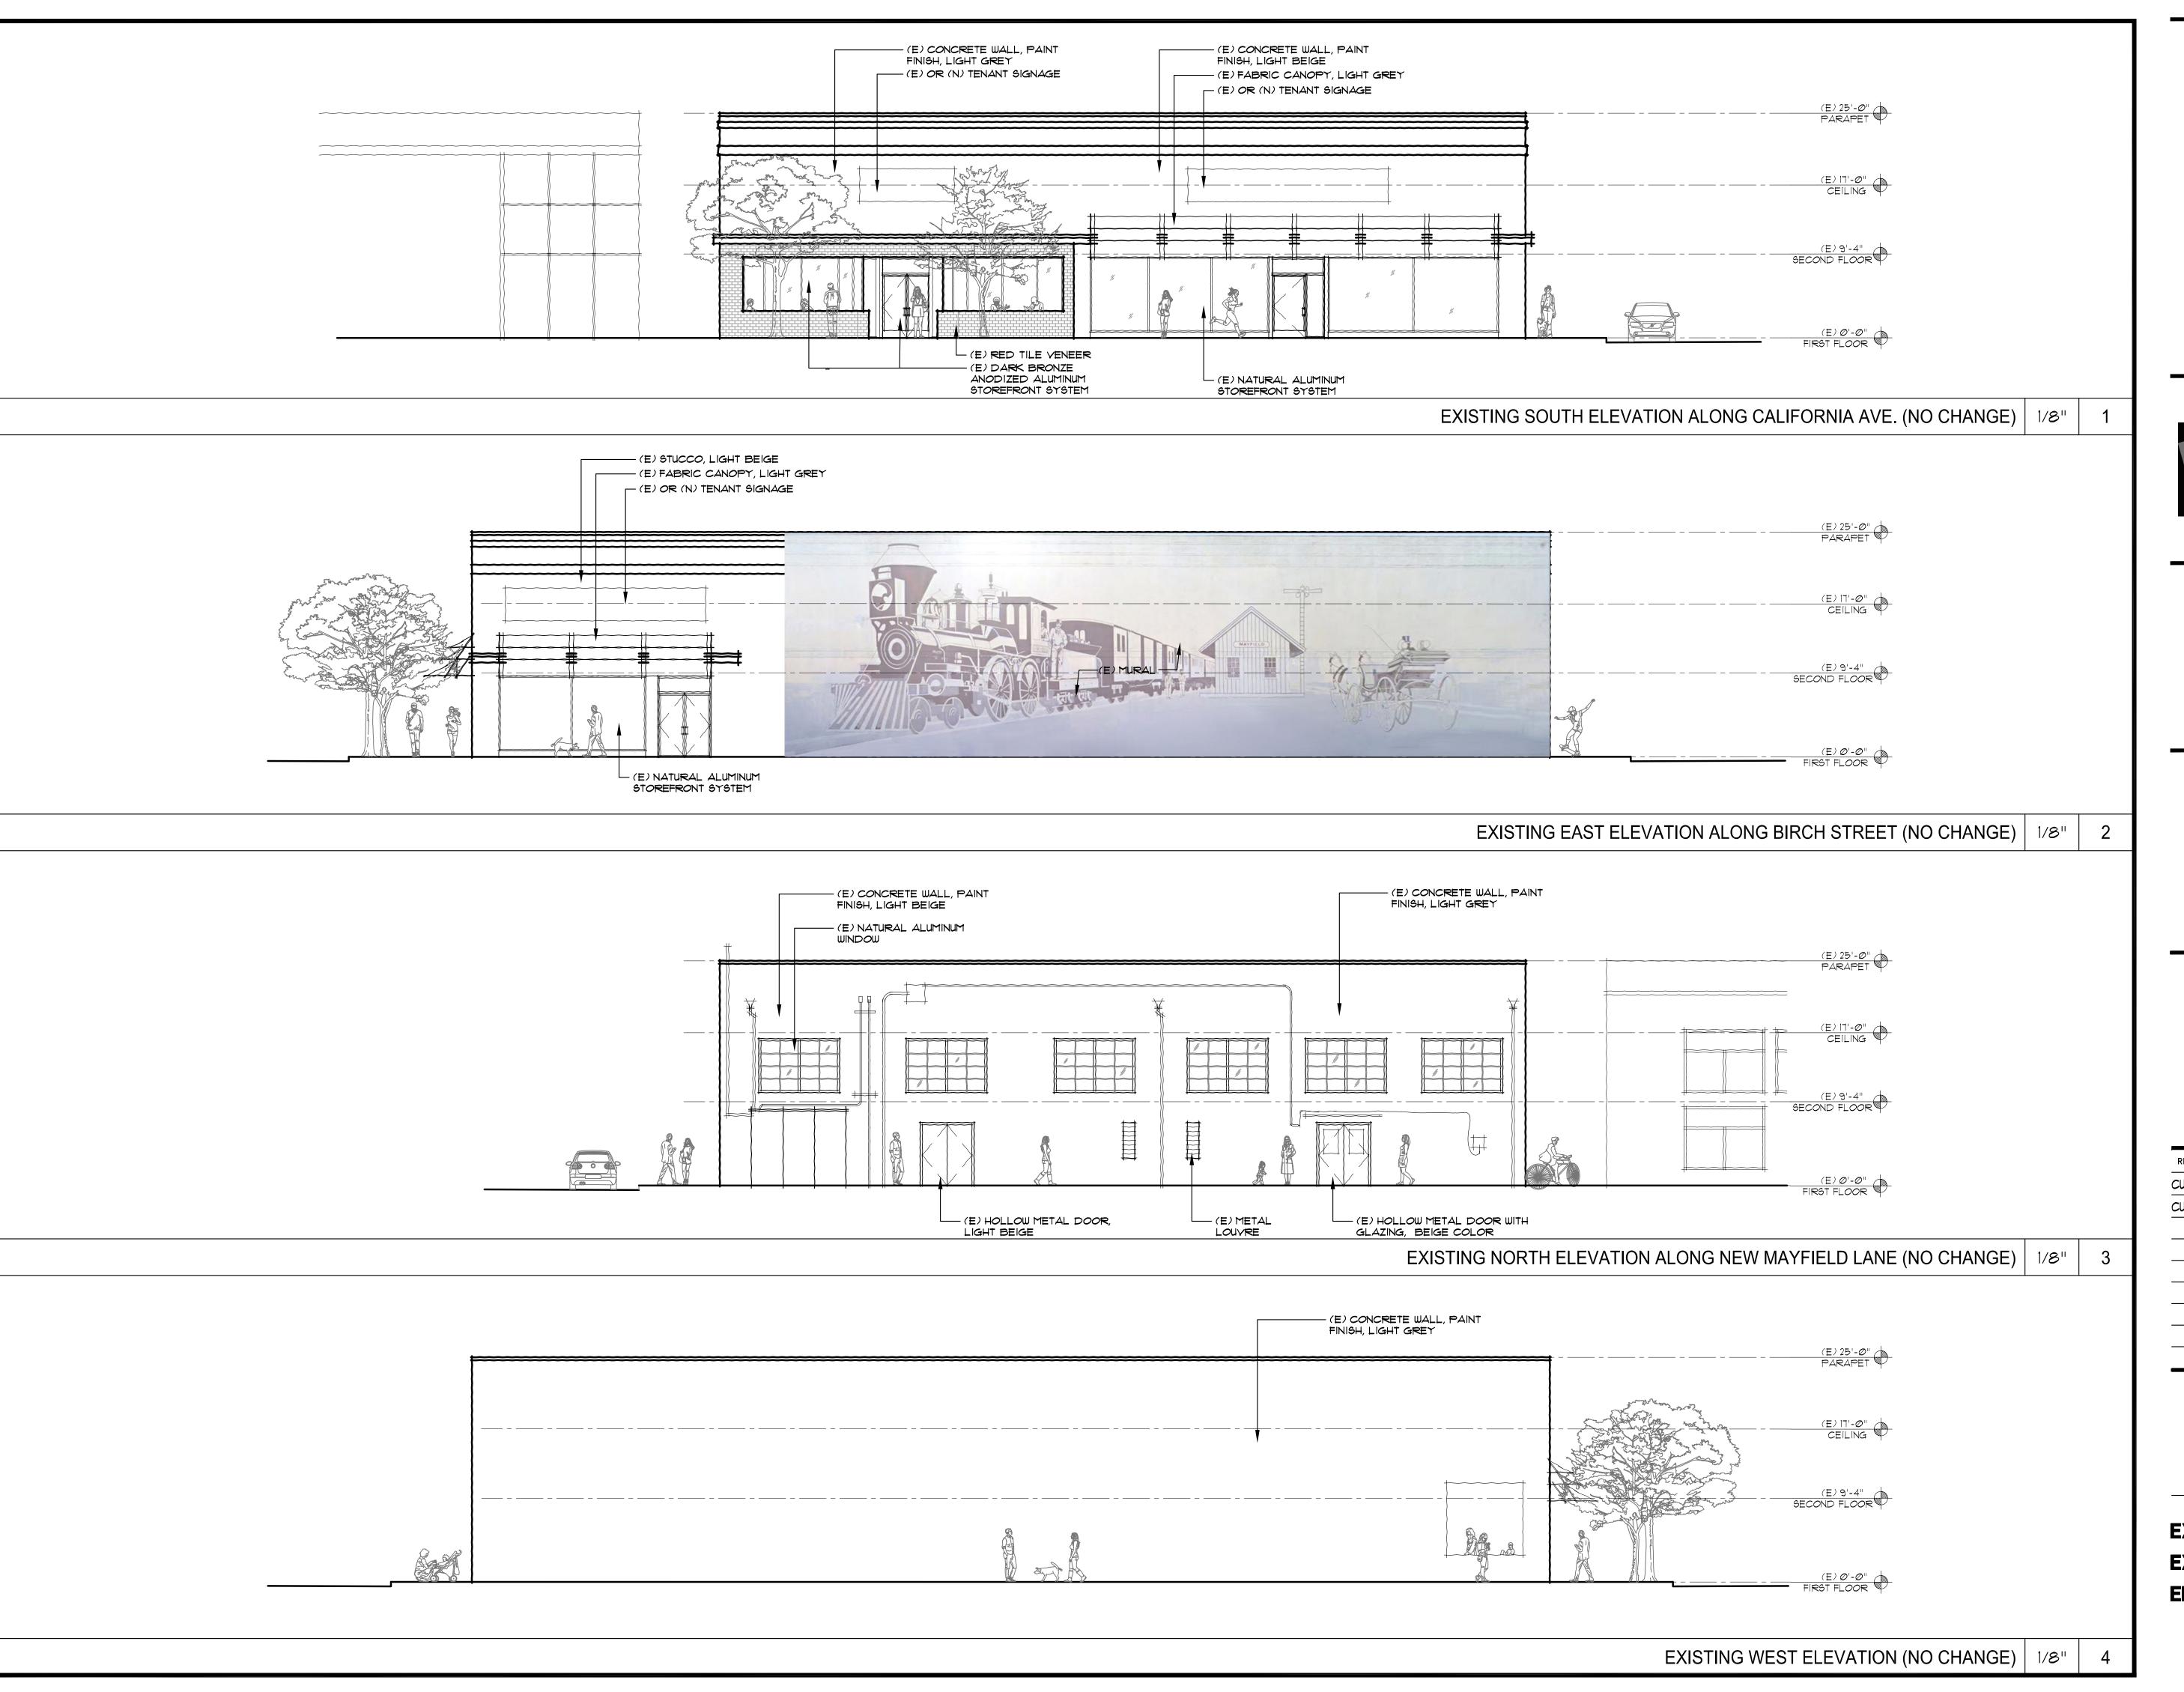

310-320 CALIFORNIA AVE., PALO ALTO, CA 94306



Ko Architects, Inc. 900 High Street, Suite 1 Palo Alto, CA 94301 p: 650.853.1908 f: 650.853.1845



CUP SUBMITTAL	11.02.2023
CUP IST RESUBMITTAL	Ø1.19.2 <i>0</i> 24


PROJECT NO.	23-31
DATE	AUG 202
DRAWN BY	R

EXISTING
EXTERIOR
ELEVATIONS

SHEET

AS5.1

AS NOTED

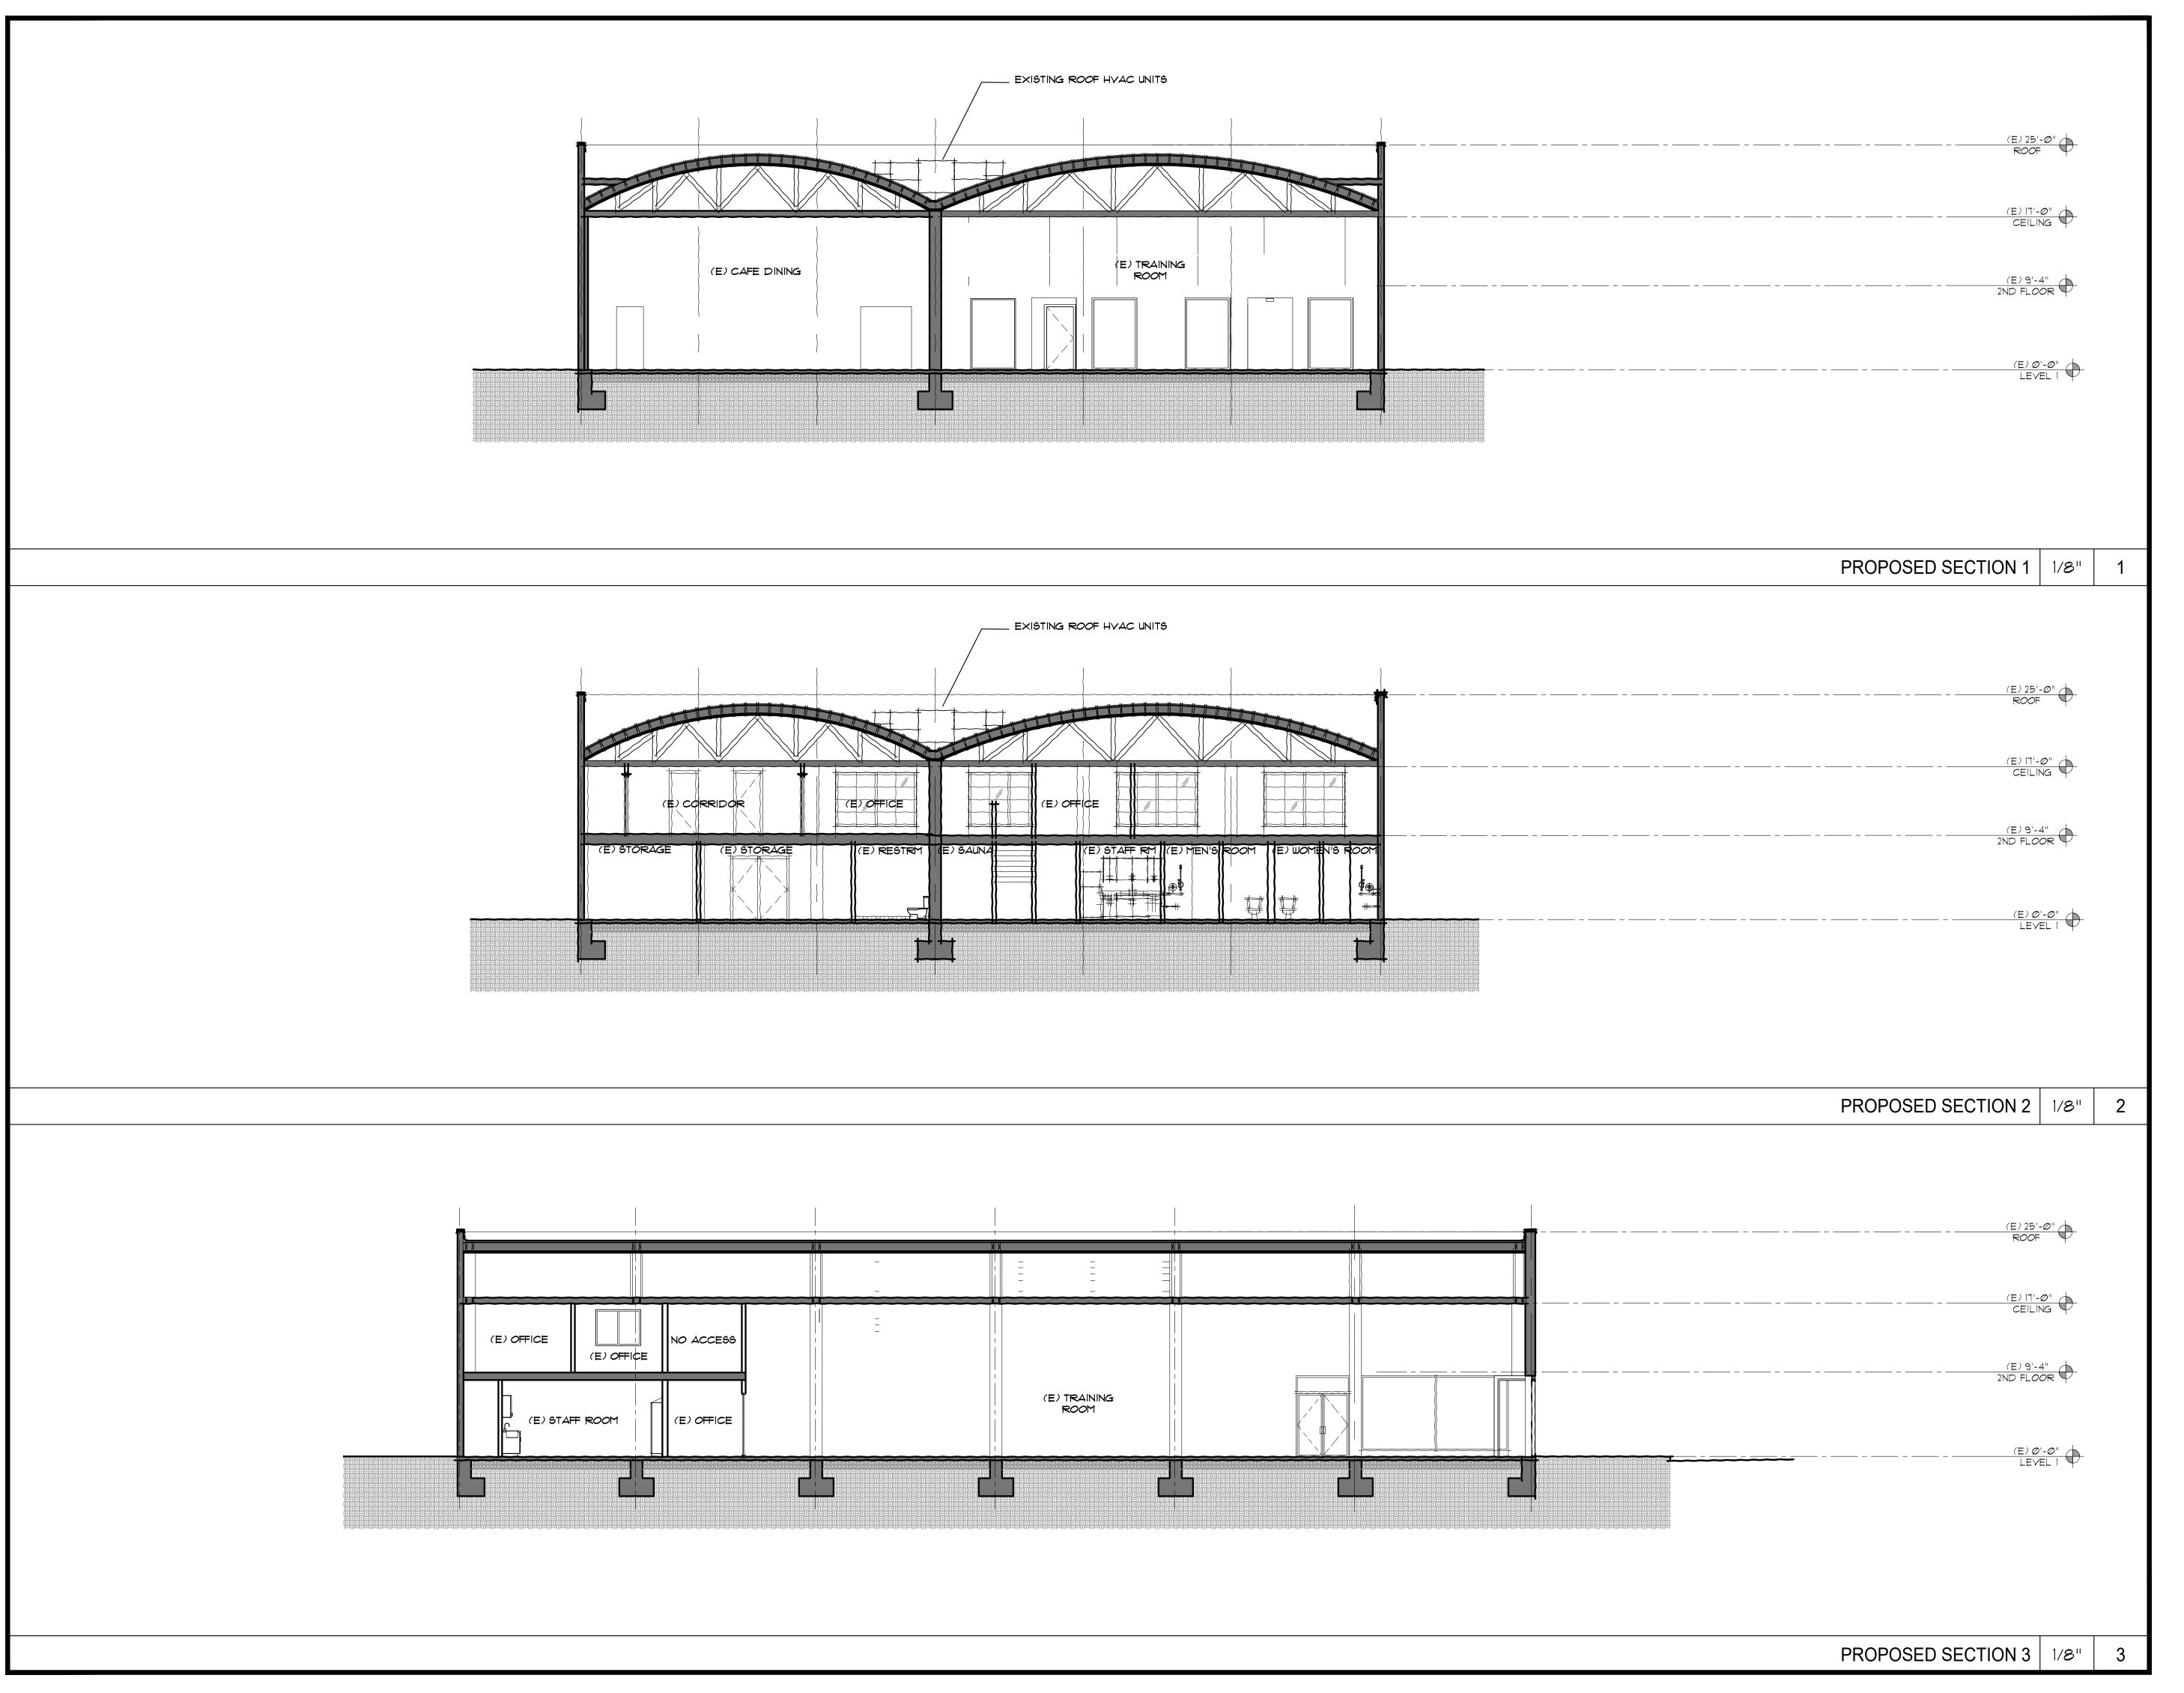

310-320 CALIFORNIA AVE., PALO ALTO, CA 94306






CUP SUBMITTAL		11.02.2023
CUP 15T RESUBMITTAL		Ø1.19.2 0 24
	PROJECT NO.	23-310
	DATE	AUG 2023

SHEET

EXISTING SECTIONS

AS6.0

AS NOTED

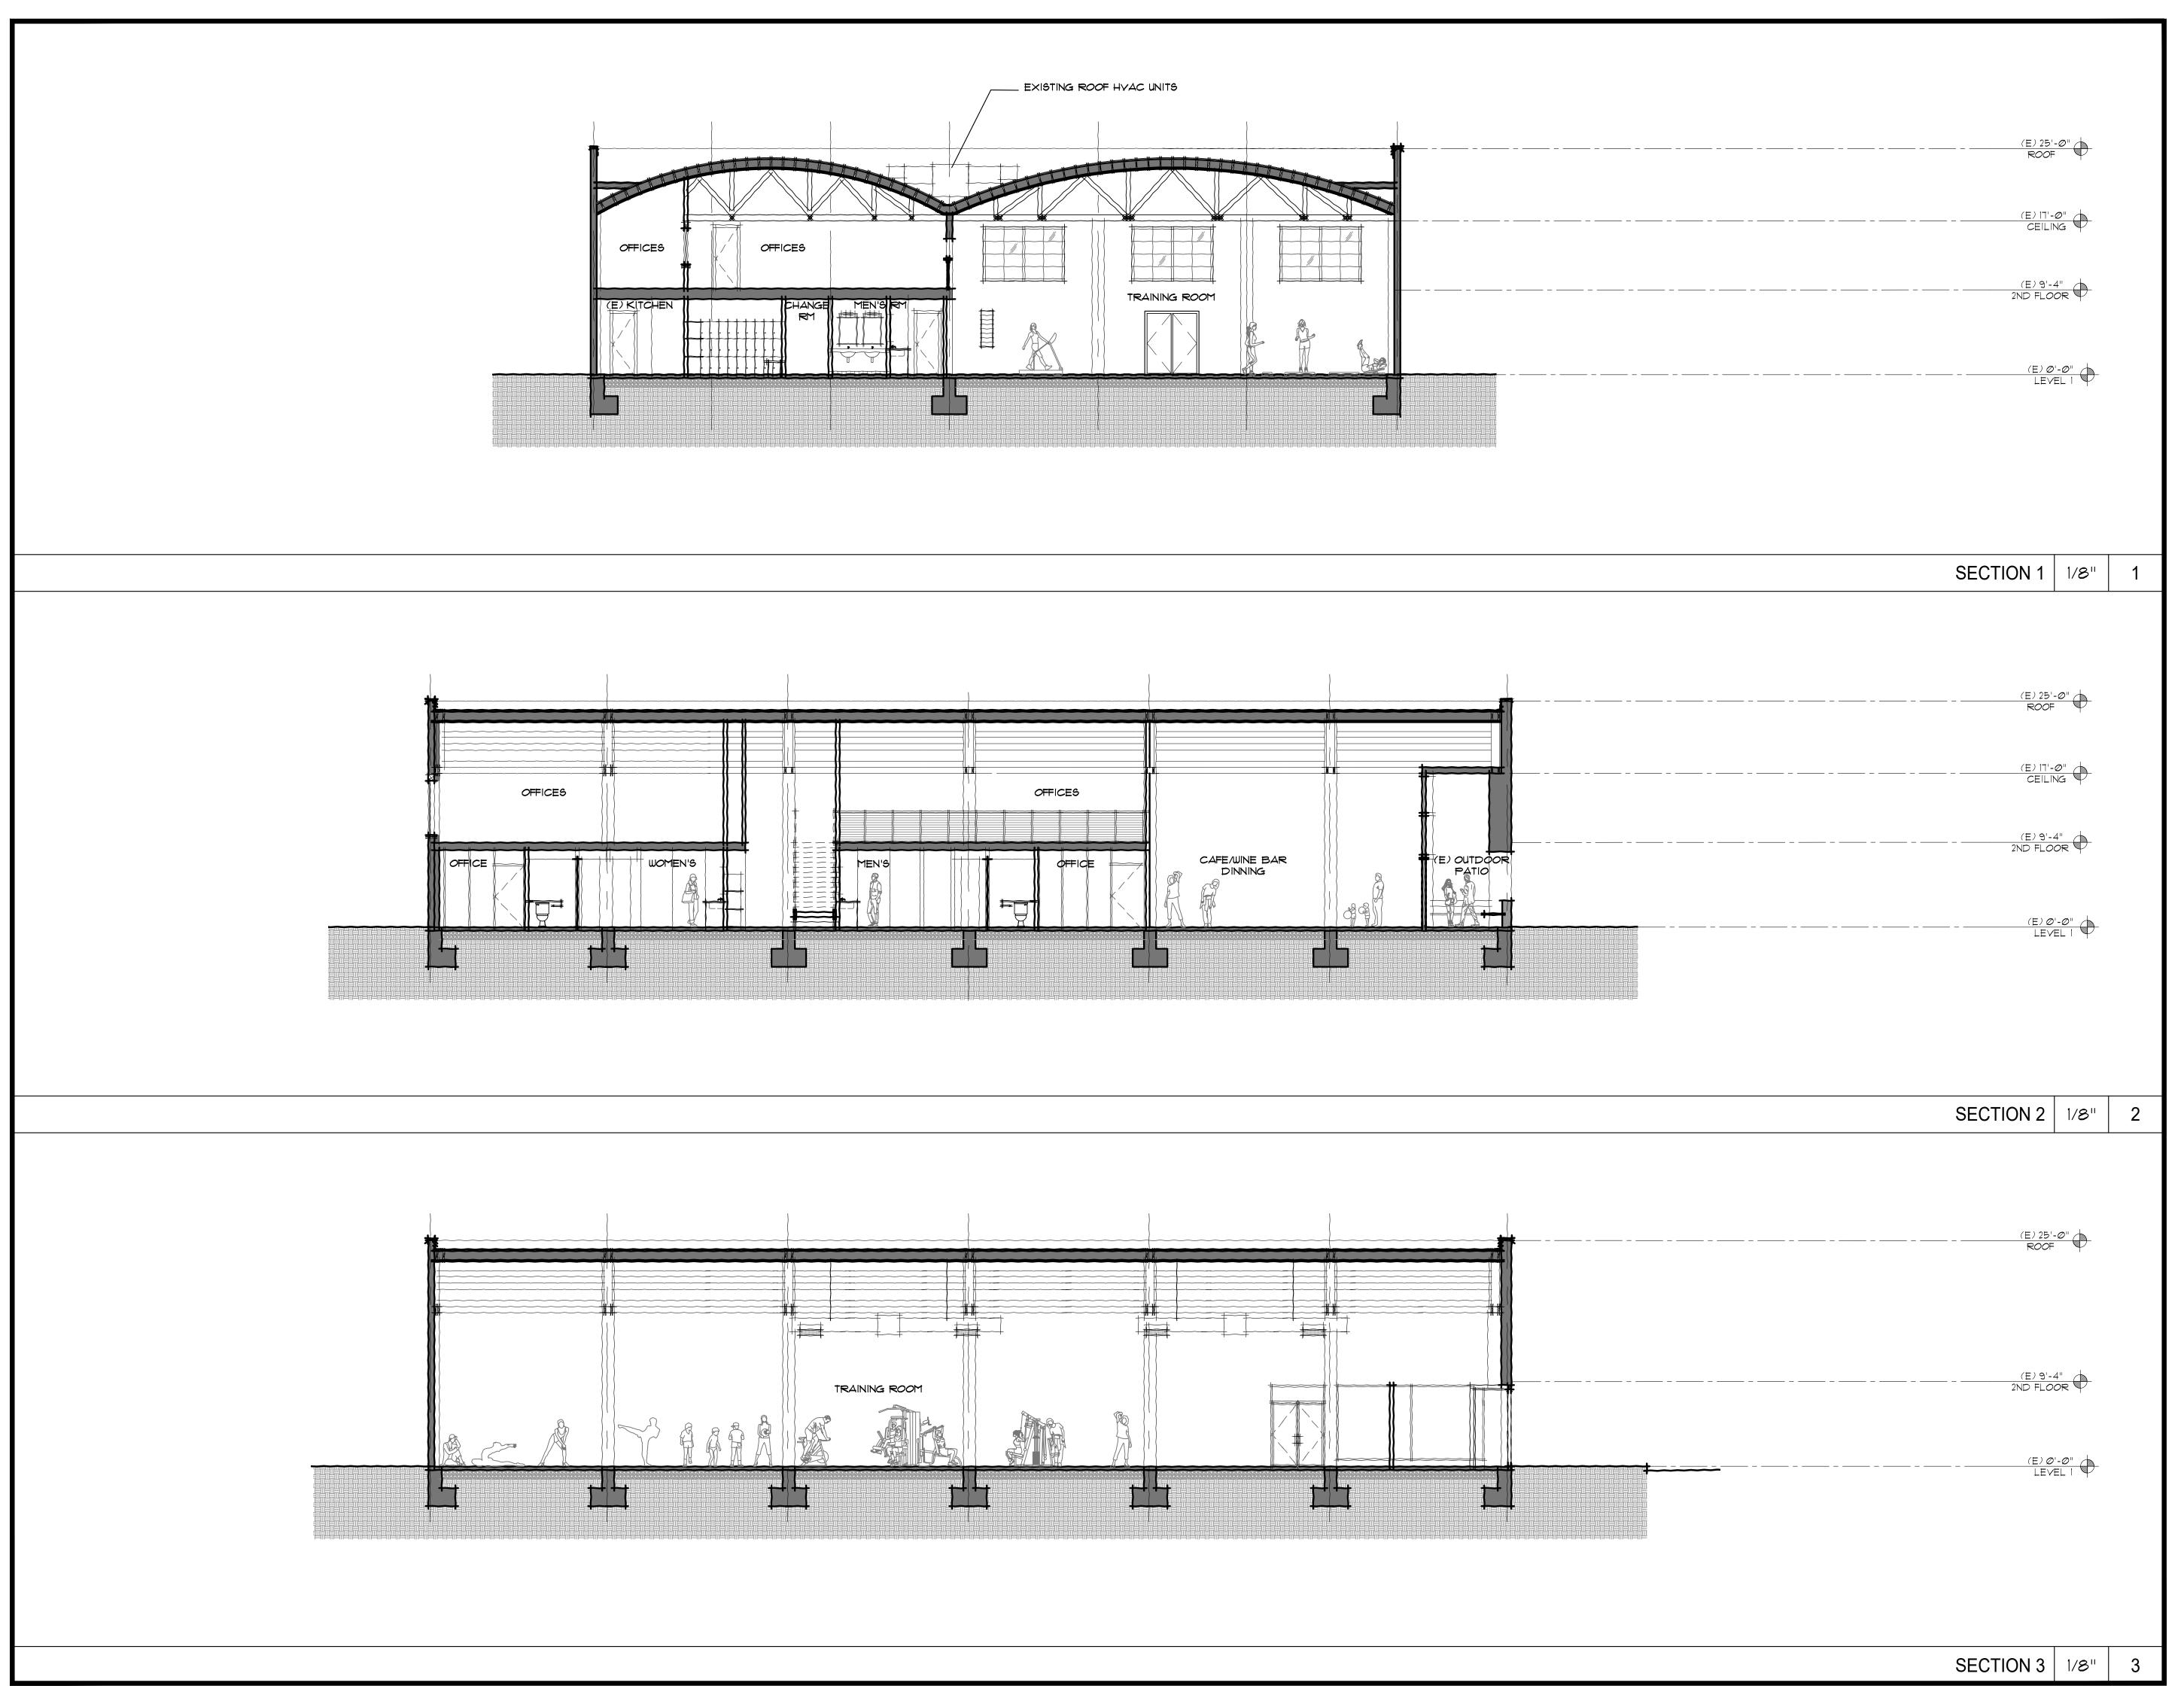

310-320 CALIFORNIA AVE., PALO ALTO, CA 94306



Ko Architects, Inc. 900 High Street, Suite 1 Palo Alto, CA 94301 p: 650.853.1908 f: 650.853.1845



CUP SUBMITTAL	11.02.2023
CUP IST RESUBMITTAL	Ø1.19.2 <i>0</i> 24

DJECT NO. 23-31Ø	
TE AUG 2023	
AWN BY RR	
ALE AS NOTED	·

PROPOSED
BUILDING
SECTIONS

SHEET

AS6.1


City of Palo Alto


Tree Protection - It's Part of the Plan!


Make sure your crews and subs do the job right!

Fenced enclosures around trees are essential to protect them by keeping the foliage canopy and branching structure clear from contact by equipment, materials and activities, preserving roots and soil conditions in an intact and non-compacted state, and identifying the Tree Protection Zone (TPZ) in which no soil disturbance is permitted and activities are restricted, unless otherwise approved. An approved tree protection report must be added to this sheet when project activity occurs within the TPZ of a regulated tree.

For detailed information on Palo Alto's regulated trees and protection during development, review the City Tree Technical Manual (TTM) found at www.cityofpaloalto.org/trees/.

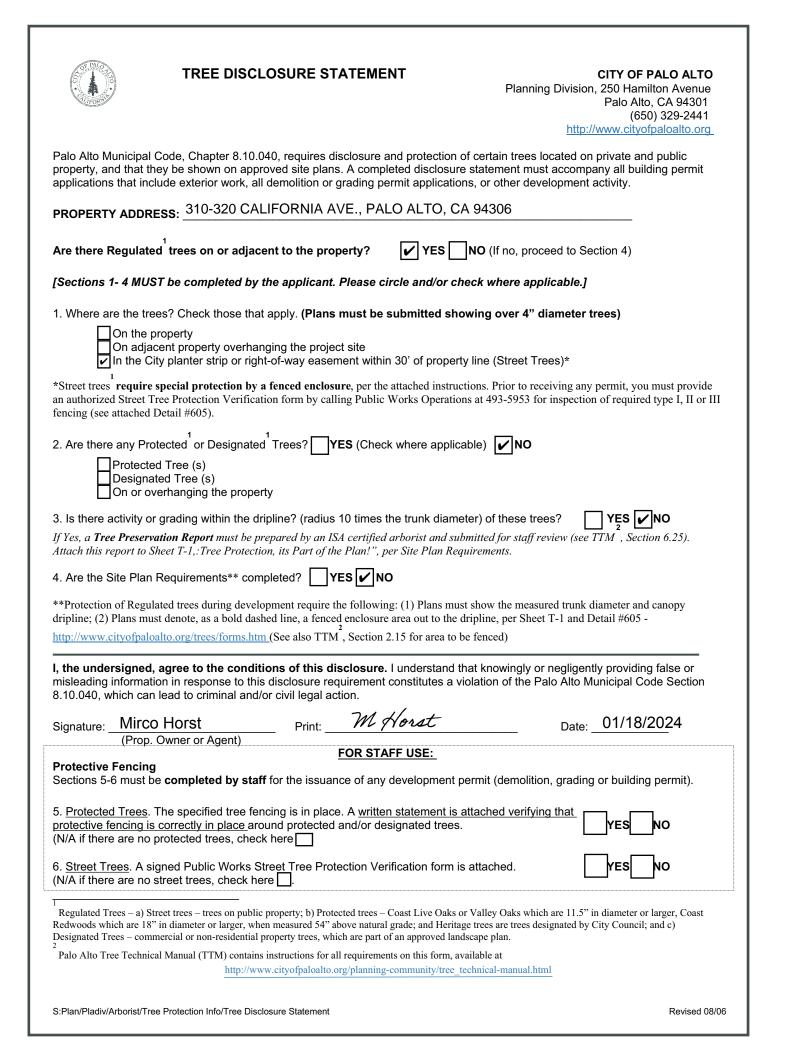

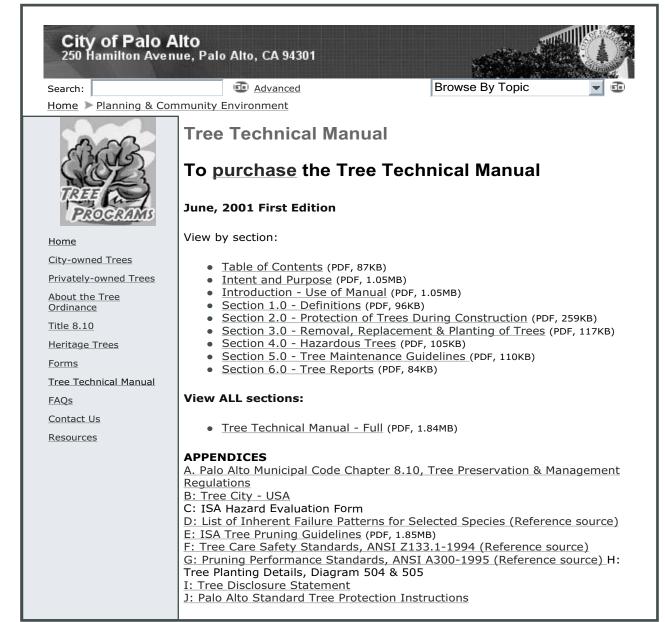

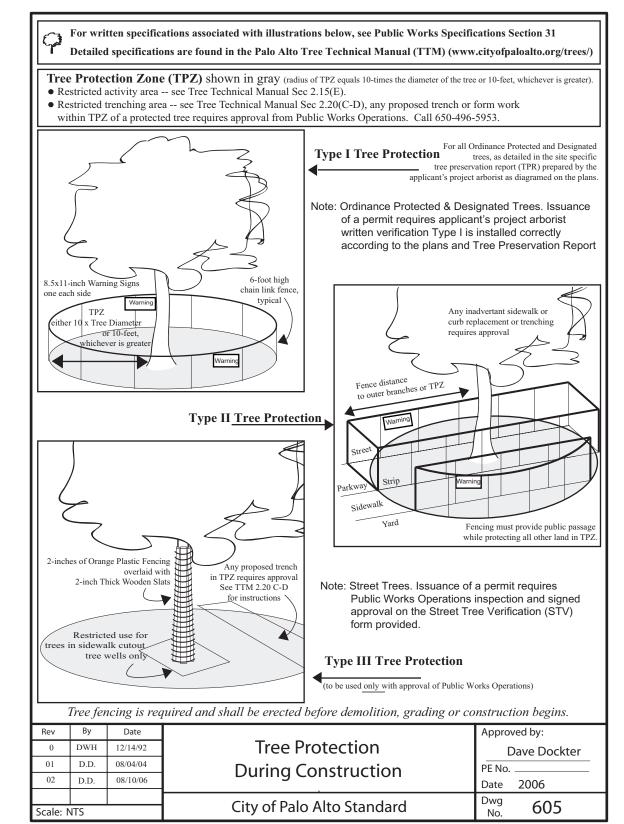

*	A TO	PALO ALTO STREET TREE PROTECTION INSTRUCTIONSSECTION 31
31-1	General	 I
	a. b.	Tree protection has three primary functions, 1) to keep the foliage canopy and branching structure clear from contact by equipment, materials and activities; 2) to preserve roots and soil conditions in an intact an non-compacted state and 3) to identify the Tree Protection Zone (TPZ) in which no soil disturbance is permitted and activities are restricted, unless otherwise approved. The Tree Protection Zone (TPZ) is a restricted area around the base of the tree with a radius of ten-time.
		the diameter of the tree's trunk or ten feet; whichever is greater, enclosed by fencing.
31-2		nce Documents
	a. b.	Detail 605 – Illustration of situations described below. Tree Technical Manual (TTM) Forms (http://www.cityofpaloalto.org/trees/)
	υ.	1. Trenching Restriction Zones (TTM, Section 2.20(C))
		2. Arborist Reporting Protocol (TTM, Section 6.30)
		3. Site Plan Requirements (TTM, Section 6.35)
	c.	4. Tree Disclosure Statement (<u>TTM</u> , Appendix J) Street Tree Verification (STV) Form (http://www.cityofpaloalto.org/trees/forms)
31-3	Executi a.	on Type I Tree Protection: The fence shall enclose the entire TPZ of the tree(s) to be protected throughout the
		life of the construction project. In some parking areas, if fencing is located on paving or concrete that will no be demolished, then the posts may be supported by an appropriate grade level concrete base, if approved by Public Works Operations.
	b.	Type II Tree Protection: For trees situated within a planting strip, only the planting strip and yard side of the TPZ shall be enclosed with the required chain link protective fencing in order to keep the sidewalk and street open for public use.
	c.	Type III Tree Protection: To be used <u>only</u> with approval of Public Works Operations. Trees situated in a tree well or sidewalk planter pit, shall be wrapped with 2-inches of orange plastic fencing from the ground to the first branch and overlaid with 2-inch thick wooden slats bound securely (slats shall not be allowed to dig into the bark). During installation of the plastic fencing, caution shall be used to avoid damaging any branches. Major limbs may also require plastic fencing as directed by the City Arborist.
	d.	Size, type and area to be fenced. All trees to be preserved shall be protected with six (6') foot high chain link fences. Fences are to be mounted on two-inch diameter galvanized iron posts, driven into the ground to a depth of at least 2-feet at no more than 10-foot spacing. Fencing shall extend to the outer branching, unless specifically approved on the STV Form.
	e.	'Warning' signs. A warning sign shall be weather proof and prominently displayed on each fence at 20-foo intervals. The sign shall be minimum 8.5-inches x 11-inches and clearly state in half inch tall letters: "WARNING - Tree Protection Zone - This fence shall not be removed and is subject to a fine according to PAMC Section 8.10.110."
	f.	Duration . Tree fencing shall be erected before demolition; grading or construction begins and remain in place until final inspection of the project, except for work specifically allowed in the TPZ. Work or soil disturbance in the TPZ requires approval by the project arborist or City Arborist (in the case of work around Street Trees). Excavations within the public right of way require a Street Work Permit from Public Works.
	g.	During construction
		 All neighbors' trees that overhang the project site shall be protected from impact of any kind. The applicant shall be responsible for the repair or replacement plus penalty of any publicly owned trees that are damaged during the course of construction, pursuant to Section 8.04.070 of the Palo Alto Municipal Code.
		 a. No storage of material, topsoil, vehicles or equipment shall be permitted within the TPZ. b. The ground under and around the tree canopy area shall not be altered. c. Trees to be retained shall be irrigated, aerated and maintained as necessary to ensure survival.

Table	2-2 Palo Alto Tree Technical Manual
	CONTRACTOR & ARBORIST INSPECTION SCHEDULE
	Reference: the Palo Alto Tree Technical Manual is available at www.cityofpaloalto.org/environment/
ALL C	HECKED ITEMS APPLY TO THIS PROJECT:
1.	
2.	Pre-Construction Meeting. Prior to commencement of construction, the applicant or contractor seconduct a pre-construction meeting to discuss tree protection with the job site superintendent, grading operators, project site arborist, City Arborist, and, if a city maintained irrigation system i involved, the Parks Manager (Contact 650-496-6962).
3. 🗹	Inspection of Rough Grading or Trenching. Contractor shall ensure the project site arborist performs an inspection during the course of rough grading or trenching adjacent to or within the TPZ to ensure trees will not be injured by compaction, cut or fill, drainage and trenching, and if required, inspect aeration systems, tree wells, drains and special paving. The contractor shall protein the project arborist at least 24 hours advance notice of such activity.
4. 🗹	Monthly Tree Activity Report Inspections. The project site arborist shall perform a minimum monthly activity inspection to monitor and advise on conditions, tree health and retention or, immediately if there are <i>any revisions</i> to the approved plans or protection measures. The Tree Technical Manual Monthly Tree Activity Report format shall be used and sent to the Planning Delandscape review staff no later than 14 days after issuance of building permit date. Fax to (650) 3 2154. (See TTM, Monthly Tree Activity Inspection Report, Addendum 11 & section 1.17).
5. 🗹	Special activity within the Tree Protection Zone. Work in the TPZ area (see also #7 below) requires the direct onsite supervision of the project arborist (see TTM, Trenching, Excavation & Equipment, Section 2.20 C).
6.	Landscape Architect Inspection. For discretionary development projects, prior to temporary or final occupancy the applicant or contractor shall arrange for the Landscape Architect to perform on site inspection of all plant stock, quality of the materials and planting (see TTM, Planting Quality, Section 5.20.1 A) and that the irrigation is functioning consistent with the approved construction plans. The Planning Dept. landscape review staff shall be in receipt of written verification of Landscape Architect approval prior to scheduling the final inspection, unless otherwise approved.
7.	List Other (please describe as called out in the site Tree Preservation Report, Sheet T-1, T-2, etc.

THE PALOS	City of Palo Al Tree Department Public Works Operations PO Box 10250 Palo Alto, C/ 650/496-5953 FAX: 650/85 treeprotection@CityofPaloA	A 94303 2-9289	Verification of Street Tree Protection
			orm. Mail or FAX this form along with signed Tree
APPLICATION I		10/20/202	
ADDRESS/LOC TREES TO BE F	ATION OF STREET PROTECTED:	310-320	CALIFORNIA AVE., PALO ALTO, CA 943
APPLICANT'S N	IAME:	Palo Alto	FIT
APPLICANT'S A	ADDRESS:	425 Porta	age Ave, Palo Alto, CA 94306
APPLICANT'S T & FAX NUMBER		650-4	41-0347
This section to b	e filled out by City Tree St	aff	
address(es)	rees at the above are adequately ne type of protection		YES NO* \(\bigcap \) * If NO, go to #2 below
Inspected by:			
Date of Inspec	ction:		
address are protected. The modifications Indicate how	s are required: the required s were communicated		
Subsequent Insp	ection		
Street trees at all to be adequately	protected:	* 1	YES ☐ NO* ☐ If NO, indicate in "Notes" below the disposition of case.
Inpsected by:			
Date of Inspecti	on:		
site, condition an installed. Also no	street trees by species, id type of tree protection ote if pictures were of sheet if necessary.		
Return approve	• •	demolition	or building permit issuance.

			Contact
M	onthly Tree Ac	tivity Repo	rt- Construction Site
Inspection Date:	Site address:	Contractor- Main Site Contact Information	#1: Job site superintendent Company: Email: Job site
Inspection #	Palo Alto, CA	Information	Office: Cell: Mail:
		Also present:	:
Distribution:	City of Palo Alto Others	Attn: Dave Dockter	Dave.dockter@cityofpaloalto.org 650-329-2440
		-	n place visions may be needed
2. Field Obser a. Tree P b. Trencl 3. Action Item a. Tree P b. Root z c. Sched	vations (general site-wide rotection Fences (TPF) and hing has/will occur s (list site-wide, by tree na rotection Fence (TPF) ne sone buffer material (woo lide sewer trench, foundate	e and list by individue number and date to be desadjusting (tree d chips) can be instead on dig with	visions may be needed tual tree number) be satisfied) and Date Due # x, x, x)
2. Field Obser a. Tree P b. Trencl 3. Action Item a. Tree P b. Root z c. Sched	vations (general site-wide rotection Fences (TPF) and hing has/will occur s (list site-wide, by tree no rotection Fence (TPF) ne none buffer material (woo hale sewer trench, foundate s (use often)	e and list by individue number and date to be desadjusting (tree d chips) can be instituted in dig with	visions may be needed tual tree number) be satisfied) and Date Due # x, x, x) alled next
2. Field Obser a. Tree P b. Trench 3. Action Item a. Tree P b. Root z c. Sched 4. Photograph 5. Tree Locatio 6. Recommend	vations (general site-wide rotection Fences (TPF) and sing has/will occur s (list site-wide, by tree no rotection Fence (TPF) ne sone buffer material (woo ale sewer trench, foundate s (use often)	e and list by individue number and date to be eds adjusting (tree d chips) can be instited ion dig with 11 sheet)	visions may be needed tual tree number) be satisfied) and Date Due # x, x, x) alled next
2. Field Obser a. Tree P b. Trench 3. Action Item a. Tree P b. Root z c. Sched 4. Photograph 5. Tree Locatio 6. Recommend 7. Past visits (1) Respectfully so	vations (general site-wide rotection Fences (TPF) as aing has/will occur s (list site-wide, by tree notection Fence (TPF) nesone buffer material (woo ale sewer trench, foundates (use often) on Map (mandatory 8.5 x dations, notes or monitor sitest carry-over items satisful abmitted,	e and list by individue number and date to be eds adjusting (tree d chips) can be instited ion dig with 11 sheet) items for project/staffied/still outstandin	visions may be needed tual tree number) be satisfied) and Date Due # x, x, x) alled next aff/schedule

---WARNING--Tree Protection Zone

This fencing shall not be removed without City Arborist approval (650-496-5953)

Removal without permission is subject to a \$500 fine per day*

*Palo Alto Municipal Code Section 8.10.110

City of Palo Alto Tree Protection Instructions are located at http://www.city.palo-alto.ca.us/trees/technical-manual.html

SPECIAL INSPECTIONS

TREE PROTECTION INSPECTIONS MANDATORY

PAMC 8.10 PROTECTED TREES. CONTRACTOR SHALL ENSURE PROJECT SITE ARBORIST IS PERFORMING REQUIRED TREE INSPECTION AND SITE MONITORING. PROVIDE WRITTEN MONTHLY TREE ACTIVITY REPORTS TO THE PLANNING DEPARTMENT LANDSCAPE REVIEW STAFF BEGINNING 14 DAYS AFTER BUILDING PERMIT ISSUANCE.

BUILDING PERMIT DATE:


DATE OF 1ST TREE ACTIVITY REPORT:

CITY STAFF:

REPORTING DETAILS OF THE MONTHLY TREE ACTIVITY REPORT SHALL CONFORM TO SHEET T-1 FORMAT VERIFY THAT ALL TREE PROTECTION MEASURES ARE IMPLIMENTED AND WILL INCLUDE ALL CONTRACTOR ACTIVITY, SCHEDULED OR UNSCHEDULED, WITHIN A TREE PROTECTION ROOT ZONE. NON-COMPLIANCE IS SUBJECT TO VIOLATION OF PAMC 8.10.080. REFERENCE: PALO ALTO TREE TECHNICAL MANUAL

Apply Tree Protection Report on sheet(s) T-2

Use addtional "T" sheets as needed

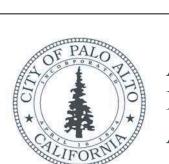

All other tree-related reports shall be added to the space provided on this sheet (adding as needed) Include this sheet(s) on Project Sheet Index or Legend Page.

A copy of T-1 can be downloaded at http://www.cityofpaloalto.org/civica/filebank/blobdload.asp?BlobID=6460

Special Tree Protection Instruction Sheet
City of Palo Alto

ECTION 2.00 AND ADDENDUM 11.

